


ROBIN HALL EXPANSION

3000 NORTHWEST AVE, BELLINGHAM WA, 98225 RFI SET

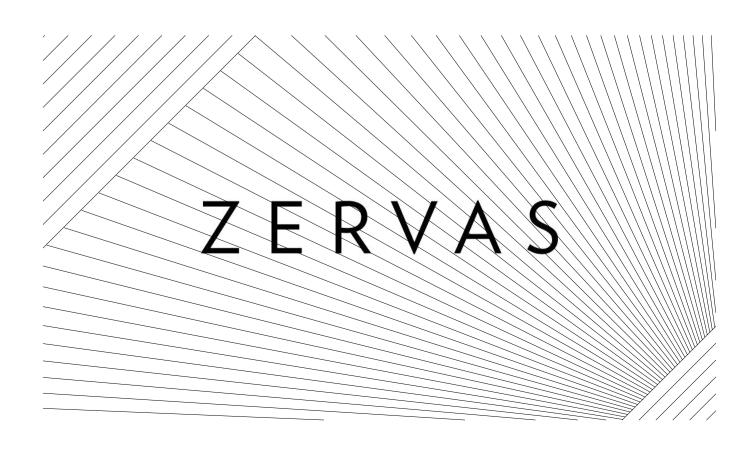



PROJECT DESCRIPTION

THE PROJECT PROPOSES AN ADDITION TO THE EXISTING ROBIN HALL AT THE FRANKLIN ACADEMY SCHOOL AT 3000 NORTHWEST AVE. REMOVING AN EXISTING ADDITION WITH 2 CLASSROOMS (2040 SF) AND ADDING 8 NEW CLASSROOMS (7450 SF). THE PRIMARY ENTRANCE REMAINS AS IS. OUTDOOR SPACE TO BE FENCED WITH A LANDSCAPING BUFFER AT NORTHWEST AVE. WITH ADDITIONAL GREENERY AROUND THE ADDITION. SITE IMPROVEMENTS INCLUDE REMOVING EXISTING COURTYARD WALLS ON THE NORTH SIDE OF THE EXISTING BUILDING, ALONG WITH RESURFACING AND RE-STRIPING OF EXISTING PARKING.

SITE INFORMATION

SITE ADDRESS: 3000 NORTHWEST

BELLINGHAM, WA 98225

PARCEL # 380224412399

LEGAL DESCRIPTION: CORNWALL PARK ACREAGE LOTS 11 THRU 14 BLK 3

SITE SIZE: 1.70 ACRES

BUILDING INFORMATION

EXISTING NET SF: 17,305 SF
TO BE DEMOLISED: 2,025 SF
NEW ADDITION: 7,425
NEW NET TOTAL SF: 22,750 SF

OWNER

FRANKLIN ACADEMY 3000 NORTHWEST AVE, BELLINGHAM WA, 98225 CONTACT: GRETCHEN BUCSKO

DEFERRED SUBMITTALS

- ELECTRICAL
- FIRE SPRINKLERS
- MANUAL/AUTO/SPRINKLER FIRE ALARM SYSTEM

DESIGN TEAM

ARCHITECT: ZERVAS 209 PROSPECT STREET BELLINGHAM, WA 98225

STRUCTURAL ENGINEER:

PH: 360.734.4744 F: 360.733.2696 CONTACT: AMY ZIMMERMAN

KINGWORKS CONSULTING ENGINEERS
600 DUPONT STREET
SUITE B
BELLINGHAM, WA 98225
PH: 360.714.8260
F: 360.714.8260
CONTACT: BERNT JOHNSON


MECHANICAL ENGINEER:
BOGARD PASCUA ENGINEERS, PS
22121 17TH AVE SE

STE 111 BOTHELL, WA 98021 PH: 425.415.6100 CONTACT: ROD PASCUA

ELECTRICAL ENGINEER:
K-ENGINEERS
208 THIRD STREET
LYNDEN, WA 98264
PH: 360.354.4757
CONTACT: STEVE TEVELDE

CIVIL ENGINEER:
FREELAND & ASSOCIATES
220 WEST CHAMPION STREET
SUITE 290
BELLINGHAM, WA 98225
PH: 360.650.1408
F: 360.650.1401
CONTACT: JP SLAGLE

ARCHITECTURAL SYMBOLS

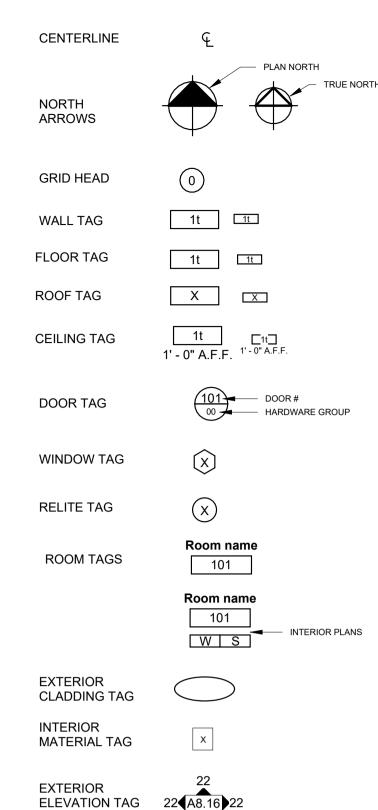


ELEVATION TAG 22 A8.16 22

⟨X⟩ ← CASEWORK #

ARCHITECTURAL ABBREVIATIONS

	TORAL ADDICEVIATIONS
&	AND
AB	AIR BARRIER
ACT AFF	ACOUSTICAL CEILING TILE ABOVE FINISHED FLOOR
AHU	AIR HANDLING UNIT
ALT	ALTERNATE
ALUM	ALUMINUM
AV BR&S	ALOMINOM AUDIO / VISUAL BACKER ROD AND SEALANT
BSMT	BASEMENT
BR	BEDROOM
BLKG	BLOCKING
BOT	BOTTOM
BO	BOTTOM OF
BLDG	BUILDING
CPT	CARPET
CT	CERAMIC TILE
CL	CENTER LINE
CLG	CEILING
CLR	CLEAR
COL	COLUMN
CONC CMU CONT	CONCRETE CONCRETE MASONRY UNIT CONTINUOUS
CI CJ	CONTINUOUS CONTINUOUS INSULATION CONTROL JOINT
DEMO DTL	DEMOLISH OR DEMOLITION DETAIL
DIA DIM(S)	DIAMETER DIMENSION(S)
DW Ó	DISHWASHÈR [°]
DN	DOWN
DS	DOWNSPOT
DR	DOOR
DWG	DWG
EA	EACH
ELEC ELEV	ELECTRICAL ELEVATION OR ELEVATOR
EQ	EQUAL
(E)	EXISTING
EXIST	EXISTING
EJ	EXPANSION JOINT
EXT	EXTERIOR
FO FOC	FACE OF FACE OF CONCRETE
FOF	FACE OF FINISH
FOM	FACE OF MASONRY
FOS	FACE OF STUD
FC	FIBER CEMENT
FFL FE	FINISHED FLOOR ELEVATION FIRE EXTINGUISHER
FEC FF	FIRE EXTINGUISHER CABINET FINISHED FACE OR FINISHED FLOOR
FRT FIN FLR	FIRE RETARDANT TREATED FINISH FLOOR
FD FTG	FLOOR FLOOR DRAIN FOOTING
GALV	GALVANIZED
GA	GAUGE
GC GLB	GENERAL CONTRACTOR GLUE LAMINATED BEAM
GWB	GYPSUM WALLBOARD
HM	HOLLOW METAL
HB	HOSE BIB
HR	HOUR
HSS ILO INSUL	HOLLOW STEEL SECTION IN LIEU OF INSULATION OR INSULATED
ID INT	INSULATION OR INSULATED INSIDE DIAMETER INTERIOR
LAV	LAVATORY
LF	LINEAL FEET
MAX	MAXIMUM
MFR	MANUFACTURER
MO	MASONRY OPENING
MECH	MECHANICAL
MTL	METAL
MIN	MINIMUM
MISC NFVA	MISCELLANEUS NET FREE VENTILATION AREA NEW
(N) NA NIC	NOT APPLICABLE NOT IN CONTRACT
NTS	NOT TO SCALE
OC	ON CENTER
OPP OH	OPPOSITE OPPOSITE HAND OR OVERHEAD
OTO	OUT TO OUT
OD	OUTSIDE DIAMETER
ORWL ORD	OVERFLOW RAINWATER LEADER OVERFLOW ROOF DRAIN
OFCC OFCI	OWNER FURNISHED, CONTRACTOR COORDINATED OWNER FURNISHED, CONTRACTOR INSTALLED OWNER FURNISHED, OWNER INSTALLED
OFOI PNT PERF	PAINT PERFORATED
PLAM	PLASTIC LAMINATE
PLYWD	PLYWOOD
PT RWL	PRESSURE TREATED RAINWATER LEADER
REF	REFERENCE
RCP	REFLECTED CEILING PLAN
REQD	REQUIRED
REV	REVISION
R	RISER
RD	ROOF DRAIN
RM	ROOM
RO	ROUGH OPENING
SCHED	SCHEDULE
SAM	SELF-ADHERED MEMBRANE
SHT	SHEET
SIM	SIM
SOG	SLAB ON GRADE
SC	SOLID CORE
SPEC	SPECIFICATION
SQ	SQUARE
SF	SQUARE FEET
SS	STAINLESS STEEL
STL	STEEL
STRUCT	STRUCTURAL
T&G	TONGUE AND GROOVE
TO TOB	TOP OF TOP OF CONCRETE
TOC TOJ TOP	TOP OF CONCRETE TOP OF JOIST TOP OF PLYWOOD
TOSOG TOS	TOP OF PLYWOOD TOP OF SLAB ON GRADE TOP OF STEEL
TOTS	TOP OF TOPPING SLAB
T	TREAD
TS	TUBE STEEL
TYP	TYP
UNO	UNLESS NOTED OTHERWISE
VB	VAPOR BARRIER
VIF VG	VERIFY IN FIELD VERTICAL GRAIN
VCT WC	VINYL COMPOSITION TILE WATER CLOSET WATER HEATER
WH WRB WWF	WATER HEATER WEATHER RESISTIVE BARRIER WELDED WIRE FABRIC
WWM WF	WELDED WIRE FABRIC WELDED WIRE MESH WIDE FLANGE
W/ W/O	WITH WITHOUT
WD	WOOD



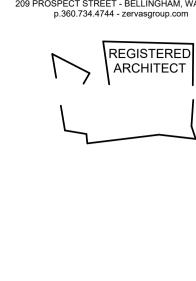

RFI SET

REV ISSUED FOR DATE

NORTH. PLAN.
SCALE.
1/4" = 1'-0"

ROBIN HALL EXPANSION

PROJECT INFORMATION

G0.01


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NORTHWEST SHOPPING CENTER





3009, 3011,3019 NORTHWEST AVE.

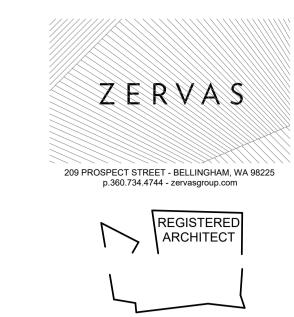

3005 NORTHWEST AVE.



EXISTING SITE





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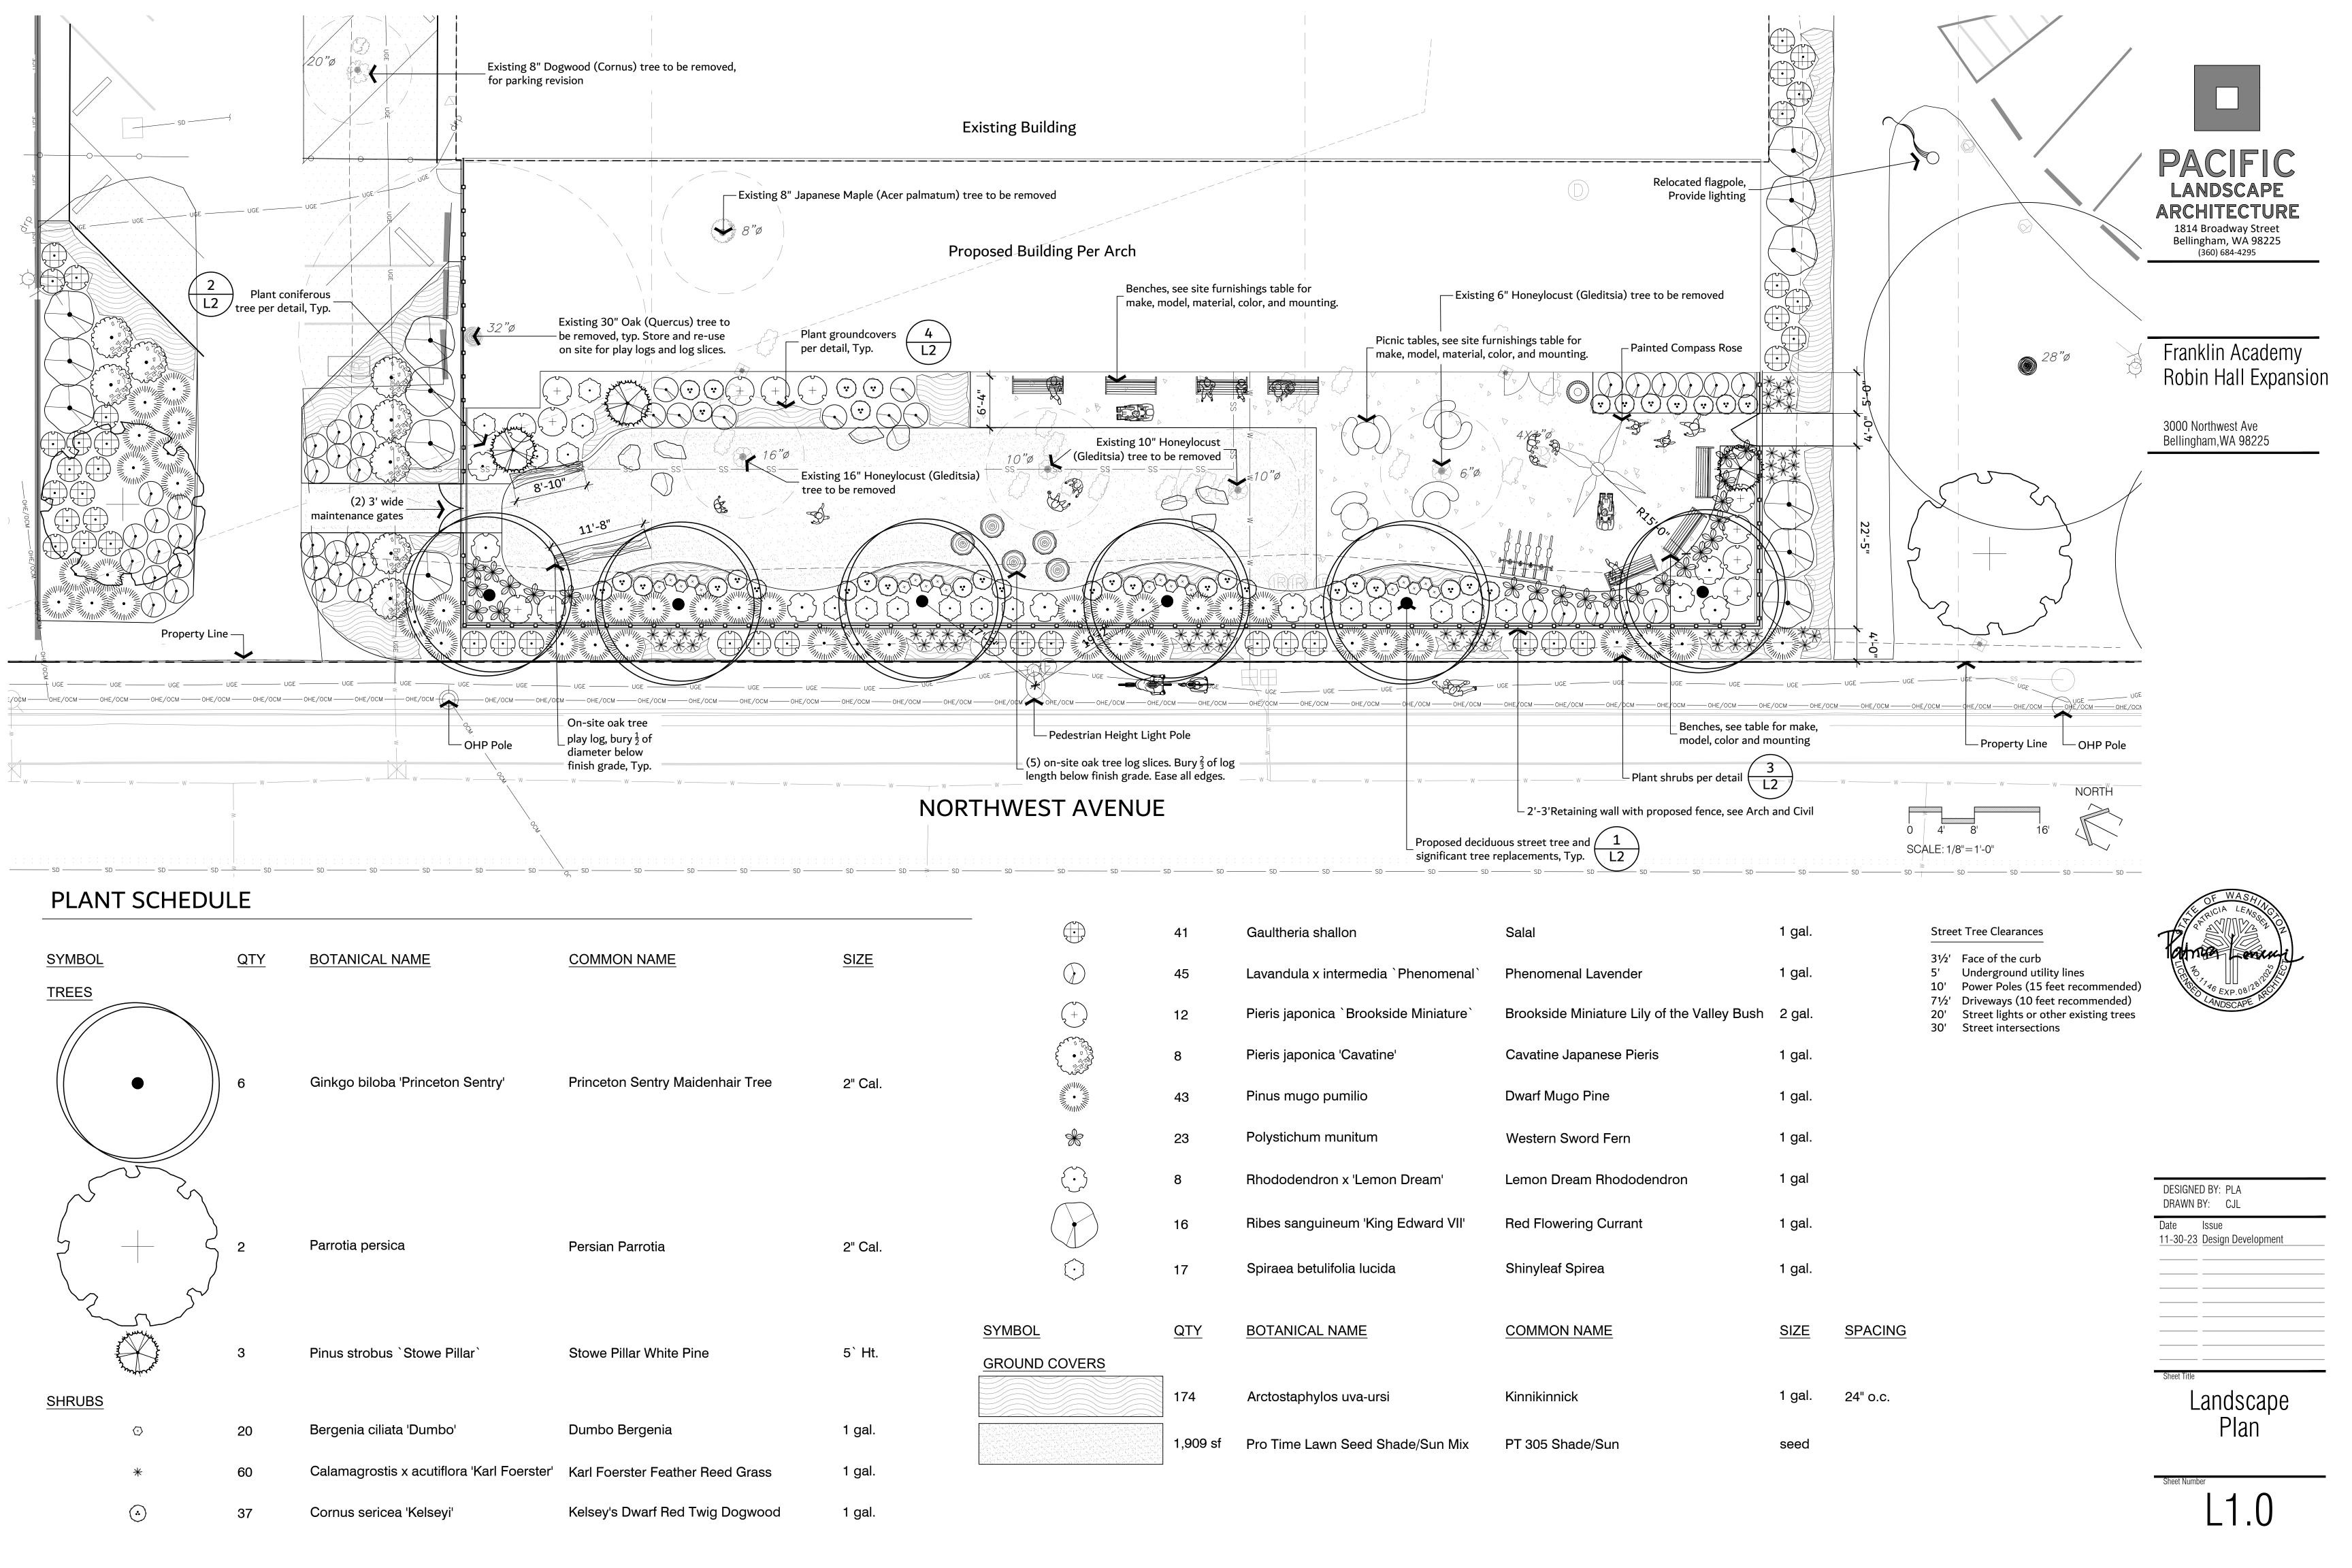



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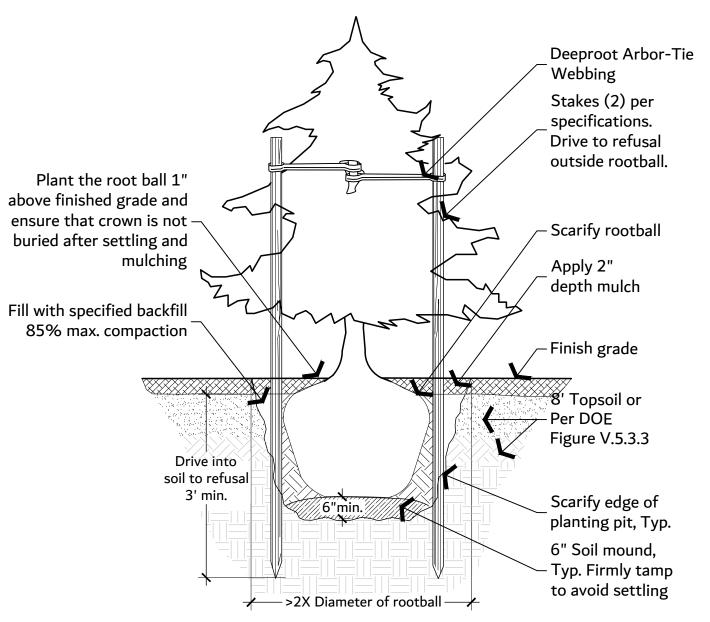
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REV ISSUED FOR DATE	E				
NORTH. PLAN. SCALE.					
ROBIN HALL EXPANSION					
PROJECT CONTEXT IMAGES					
PROJECT#. DRAWN. Author CHECK. Check ISSUED.	kei				
G0.10)				





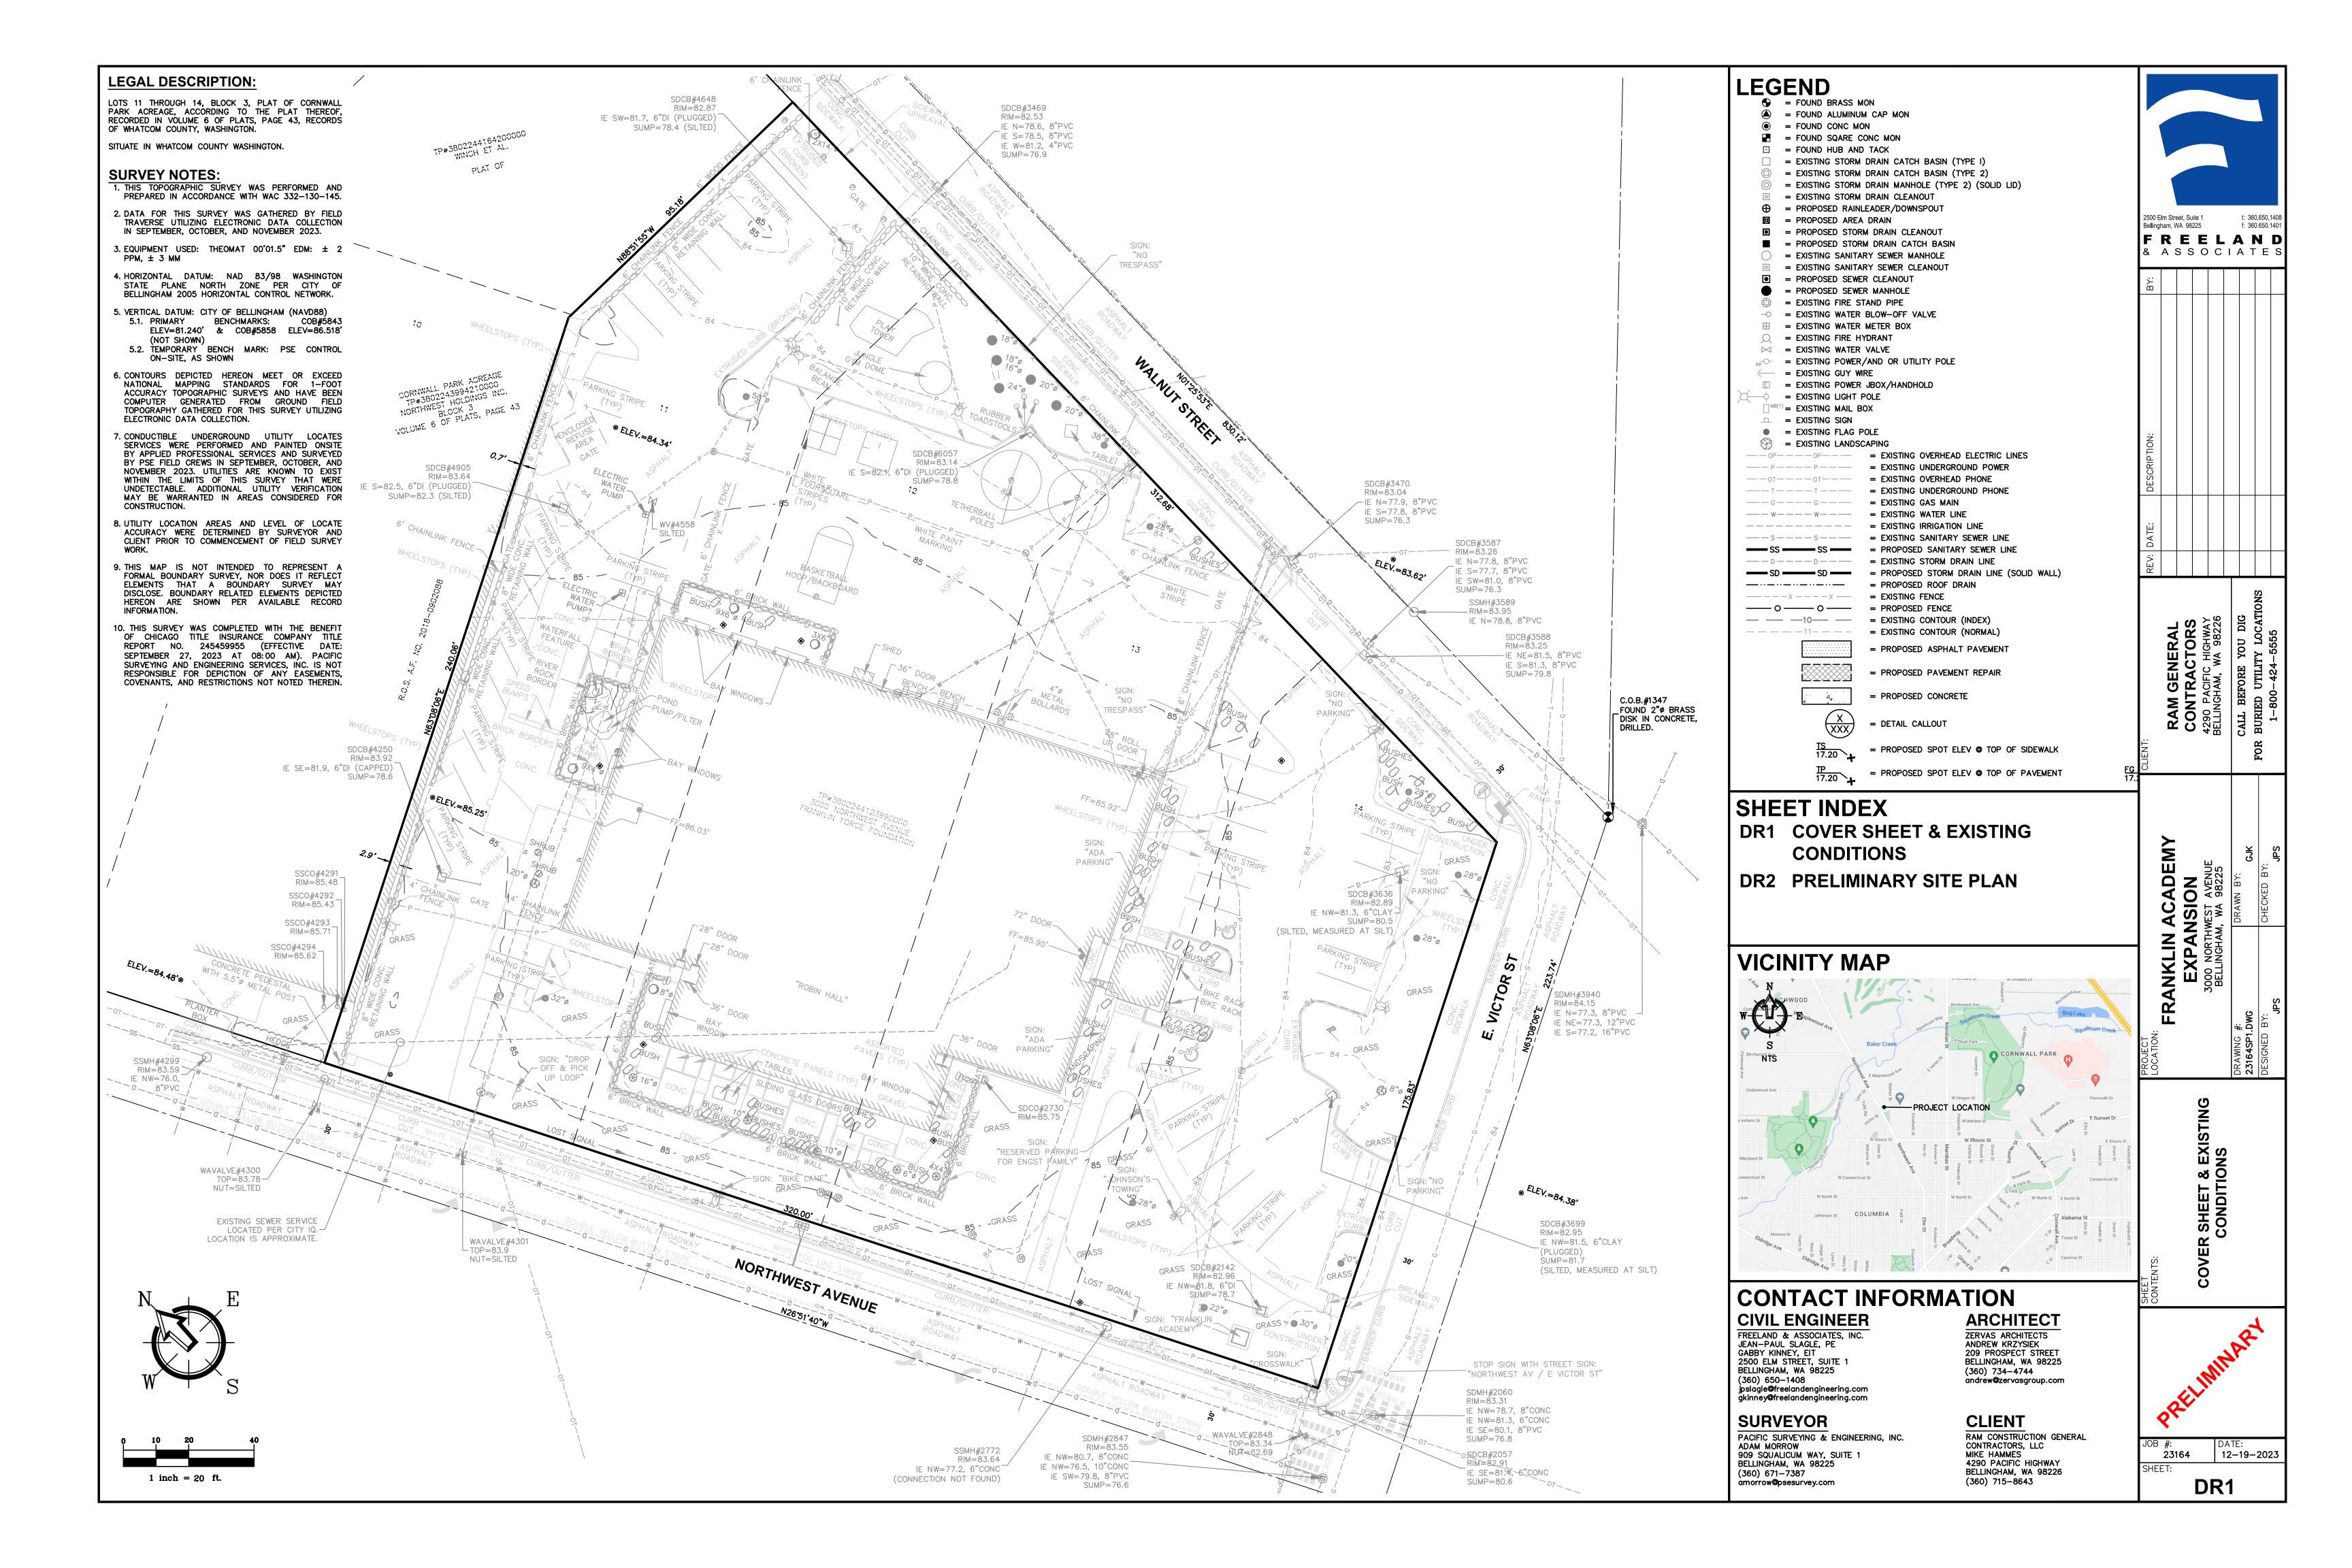

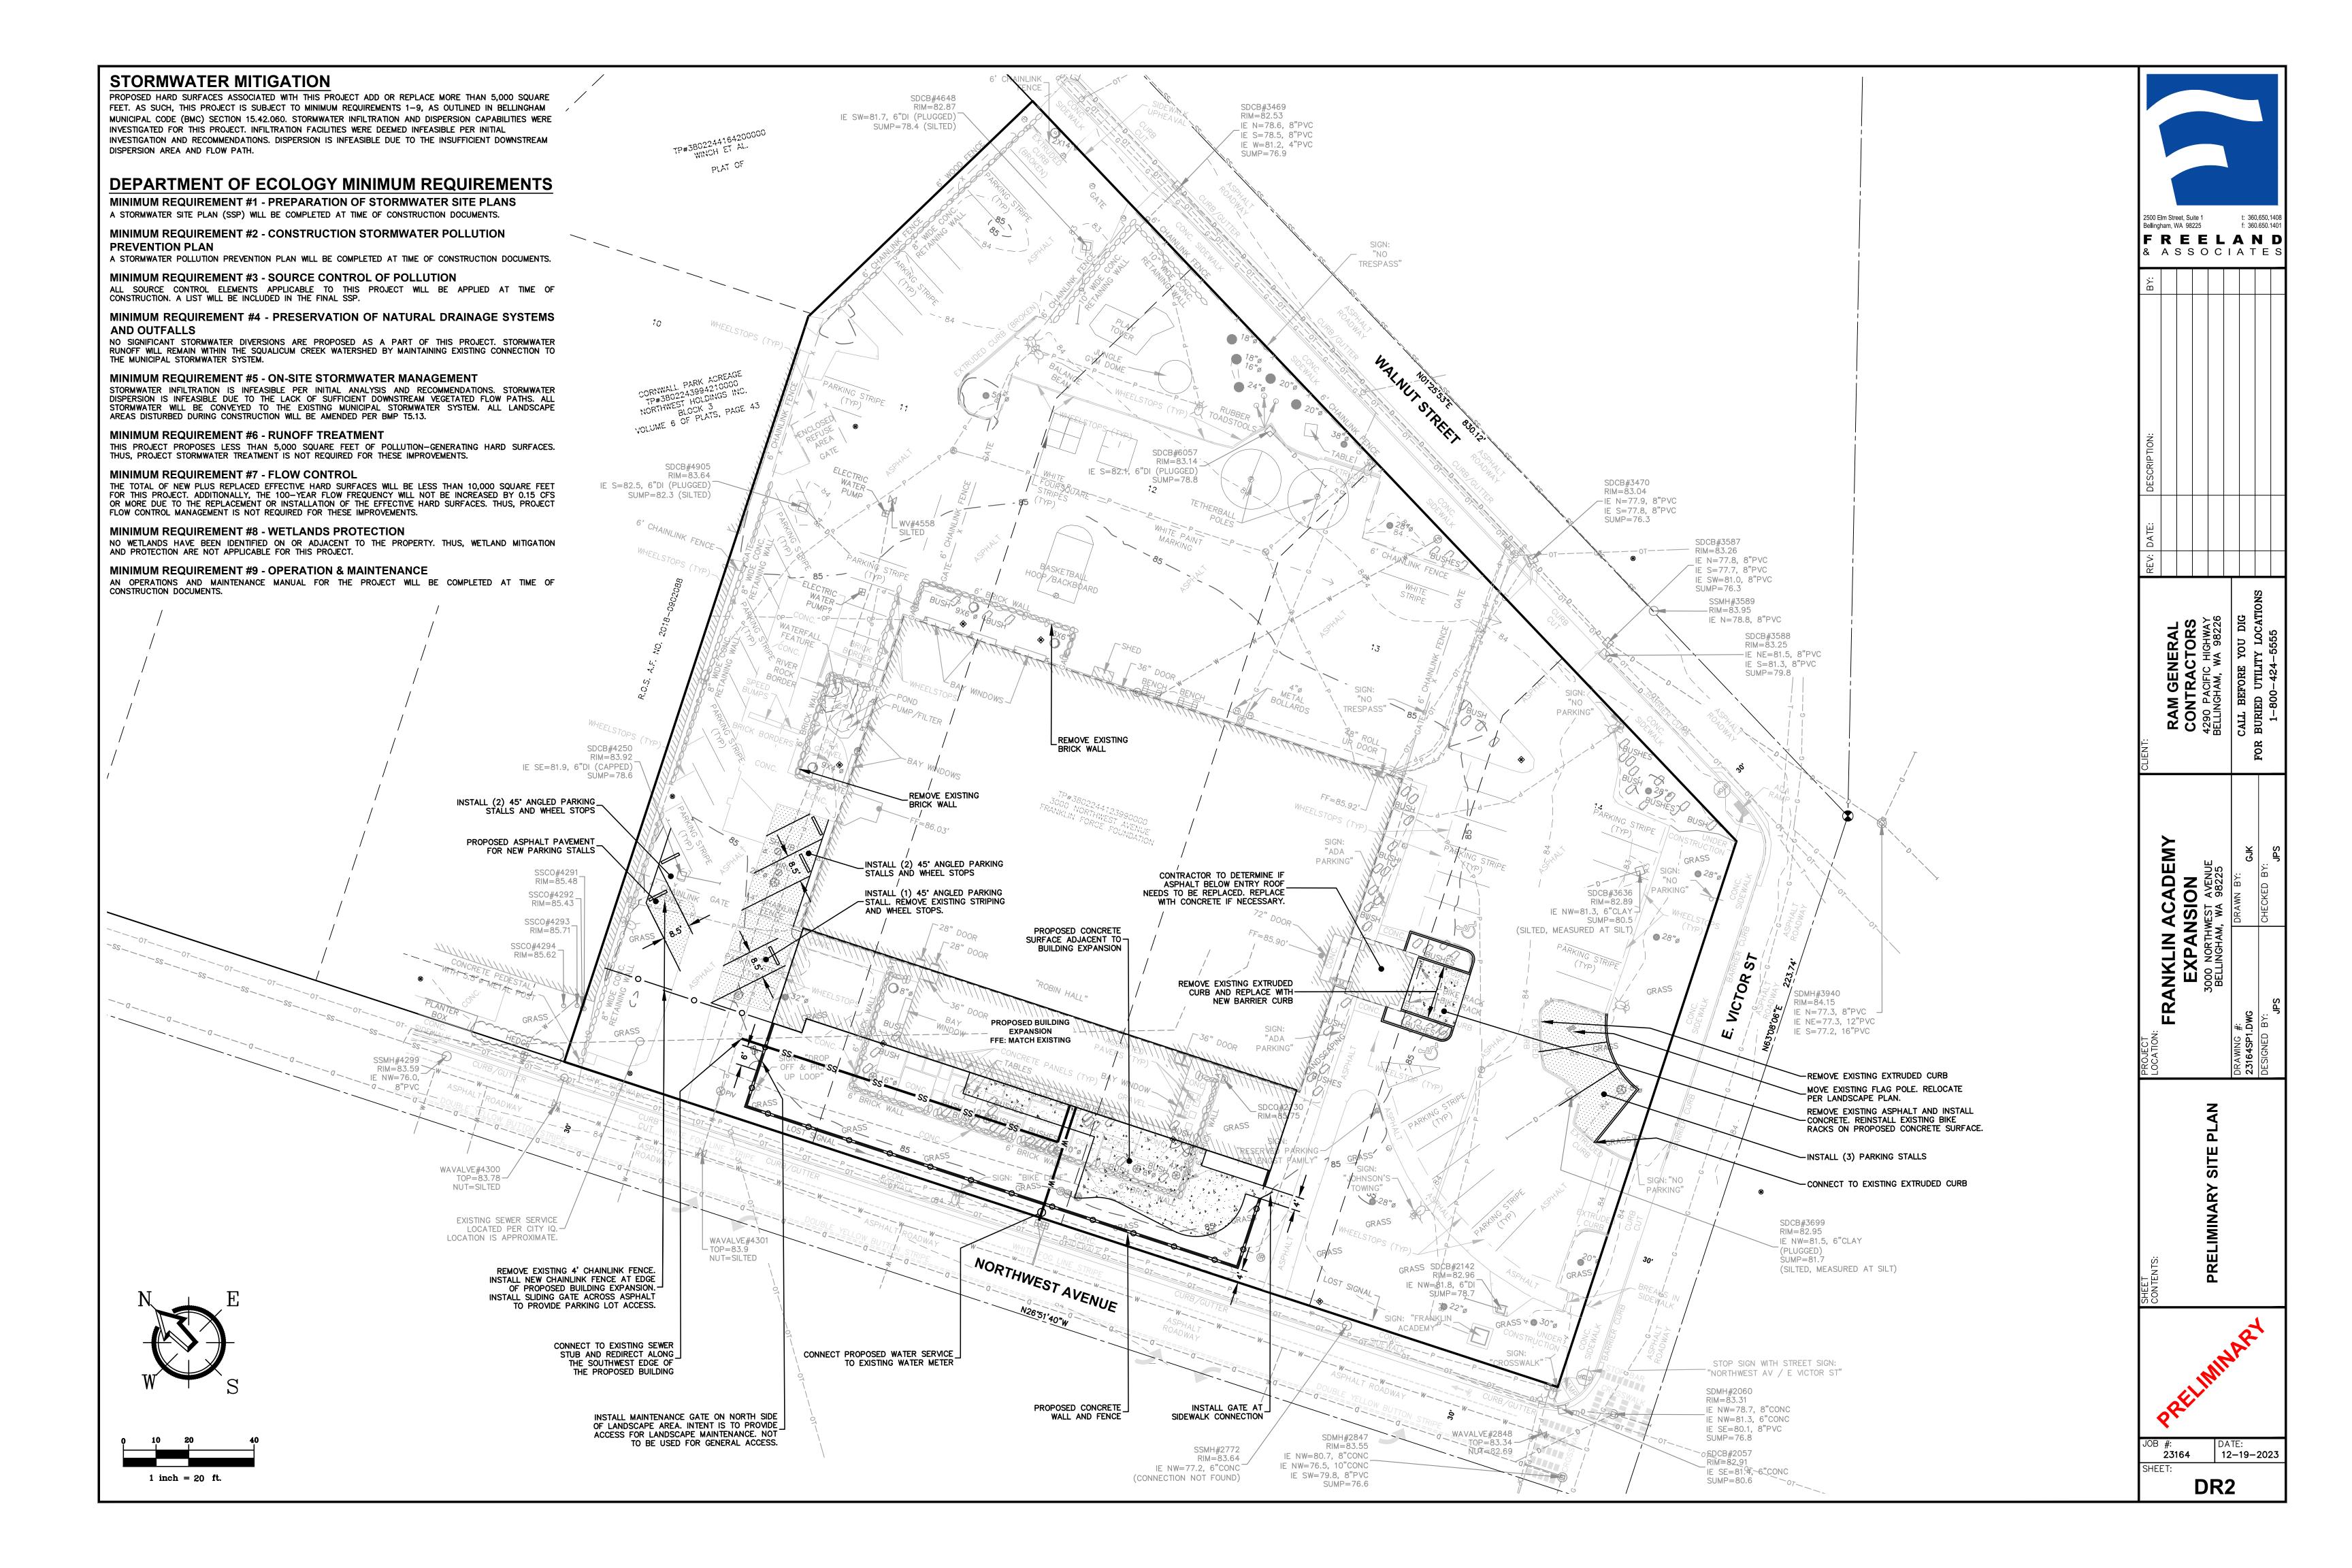


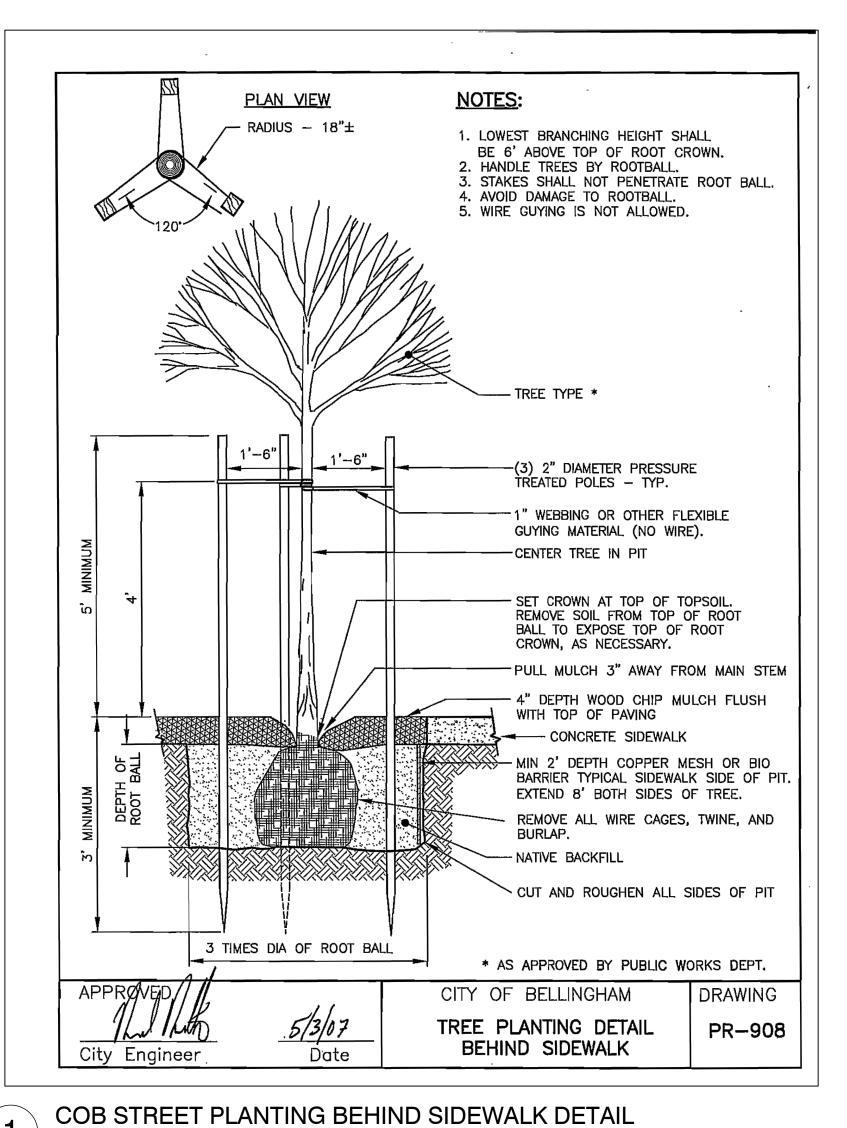

CONIFEROUS TREE PLANTING DETAIL

1/2" = 1'-0"

P-2023-FRA-15

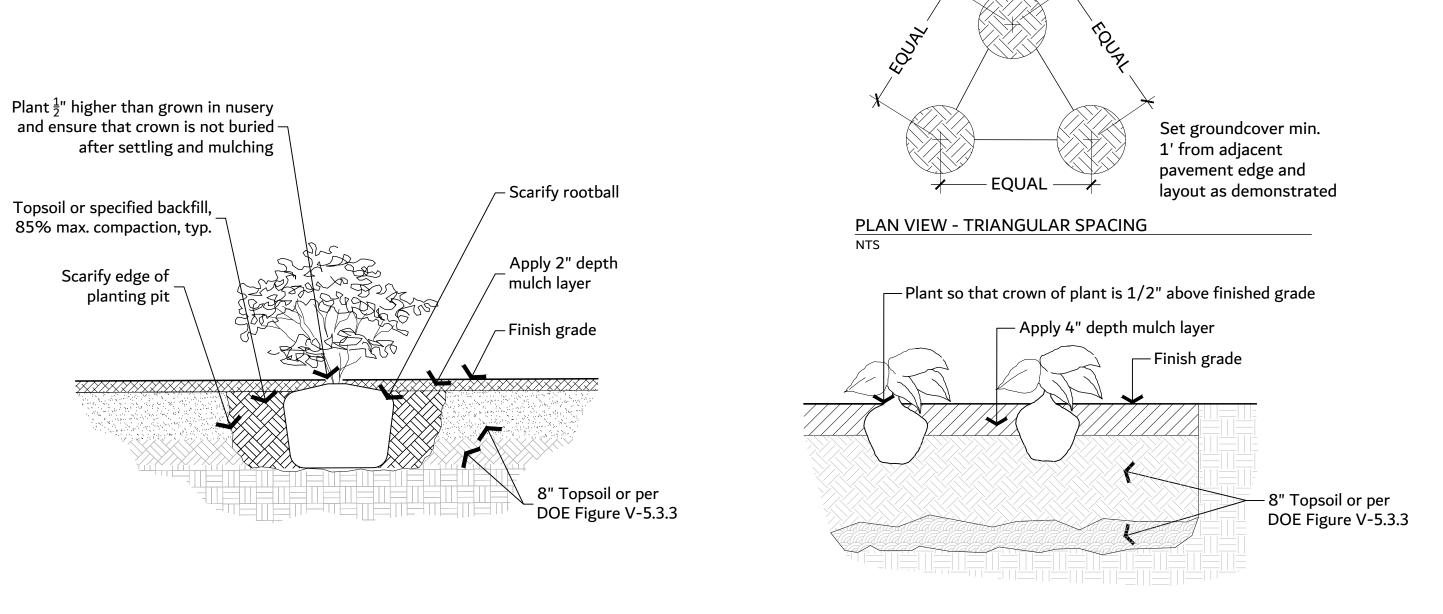

P-2023-FRA-01

GROUNDCOVER PLANTING DETAIL

SHRUB PLANTING DETAIL

3/4" = 1'-0"

P-2023-FRA-04



Franklin Academy Robin Hall Expansion

3000 Northwest Ave Bellingham,WA 98225

P-2023-FRA-06


DESIGNED BY: PLA DRAWN BY: CJL

11-30-23 Design Development

Landscape Details

SITE FURNISHINGS SCHEDULE

SYMBOL	DESCRIPTION	QTY	DETAI
	Dumor 505-60 Bench 505 with cast aluminum legs. Seat is available in ipe, thermally modified red oak, or recycled plastic, Frame: Grey Textured Gloss Slats: Thermally Modified Red Oak Surface Mount: Bolt to Concrete Surface	7	
	Dumor 157-32 32gal steel receptacle. 10in. opening. Side door emptying. Bonnet and dome cover options found at dumor.com Receptacle: Grey Textured Gloss Surface Mount: Bolt into concrete surface	1	
	Maglin FAVA-1Q-WA FAVA Cluster Seating Table. 31in. H. 40in. Dia. table top. 1 quad seat. Wheelchair accessible. Frame: Orange Gloss Surface: Grey Orangepeel HDPE Surface Mount: Bolt into concrete surface	1	
	Maglin FAVA-2D FAVA Cluster Seating Table. 31in. H. 40in. Dia. table top. 2 double seats. Frame: Orange Gloss Surface Mount: Bolt into concrete surface Surface: Grey Orangepeel HDPE Surface Mount: Bolt into concrete surface	3	

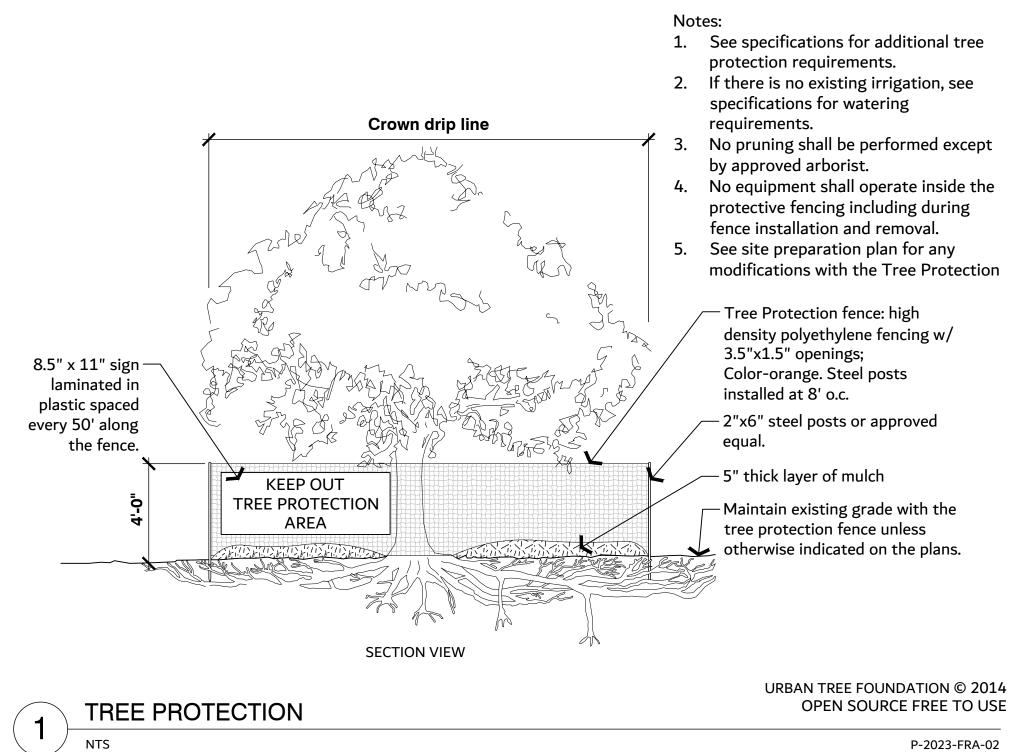


TREE RETENTION PLAN NOTES:

• X" tree notes refers to Diameter at Breast Height (DBH) caliper size of the tree trunk.

TREE PROTECTION DURING CONSTRUCTION NOTES:

- Prior to the start of construction, all tree protection areas shall have protective barrier fences erected at the edges of the root protection zones, or as shown on the plans.
- No grading, filling, operation of equipment, modifications to drainage, utility trenches, under story removal, stockpiling, storage, or other activity should occur within the root protections zones.
- Damage done by the Contractor, or any of their sub-contractors to existing or installed plants, including roots, trunk or branches of large existing trees, soil, irrigation, shall be cleaned, repaired or replaced by the Contractor at no expense to the Owner. The Owner's Representative shall determine when such cleaning, replacement or repair is satisfactory.

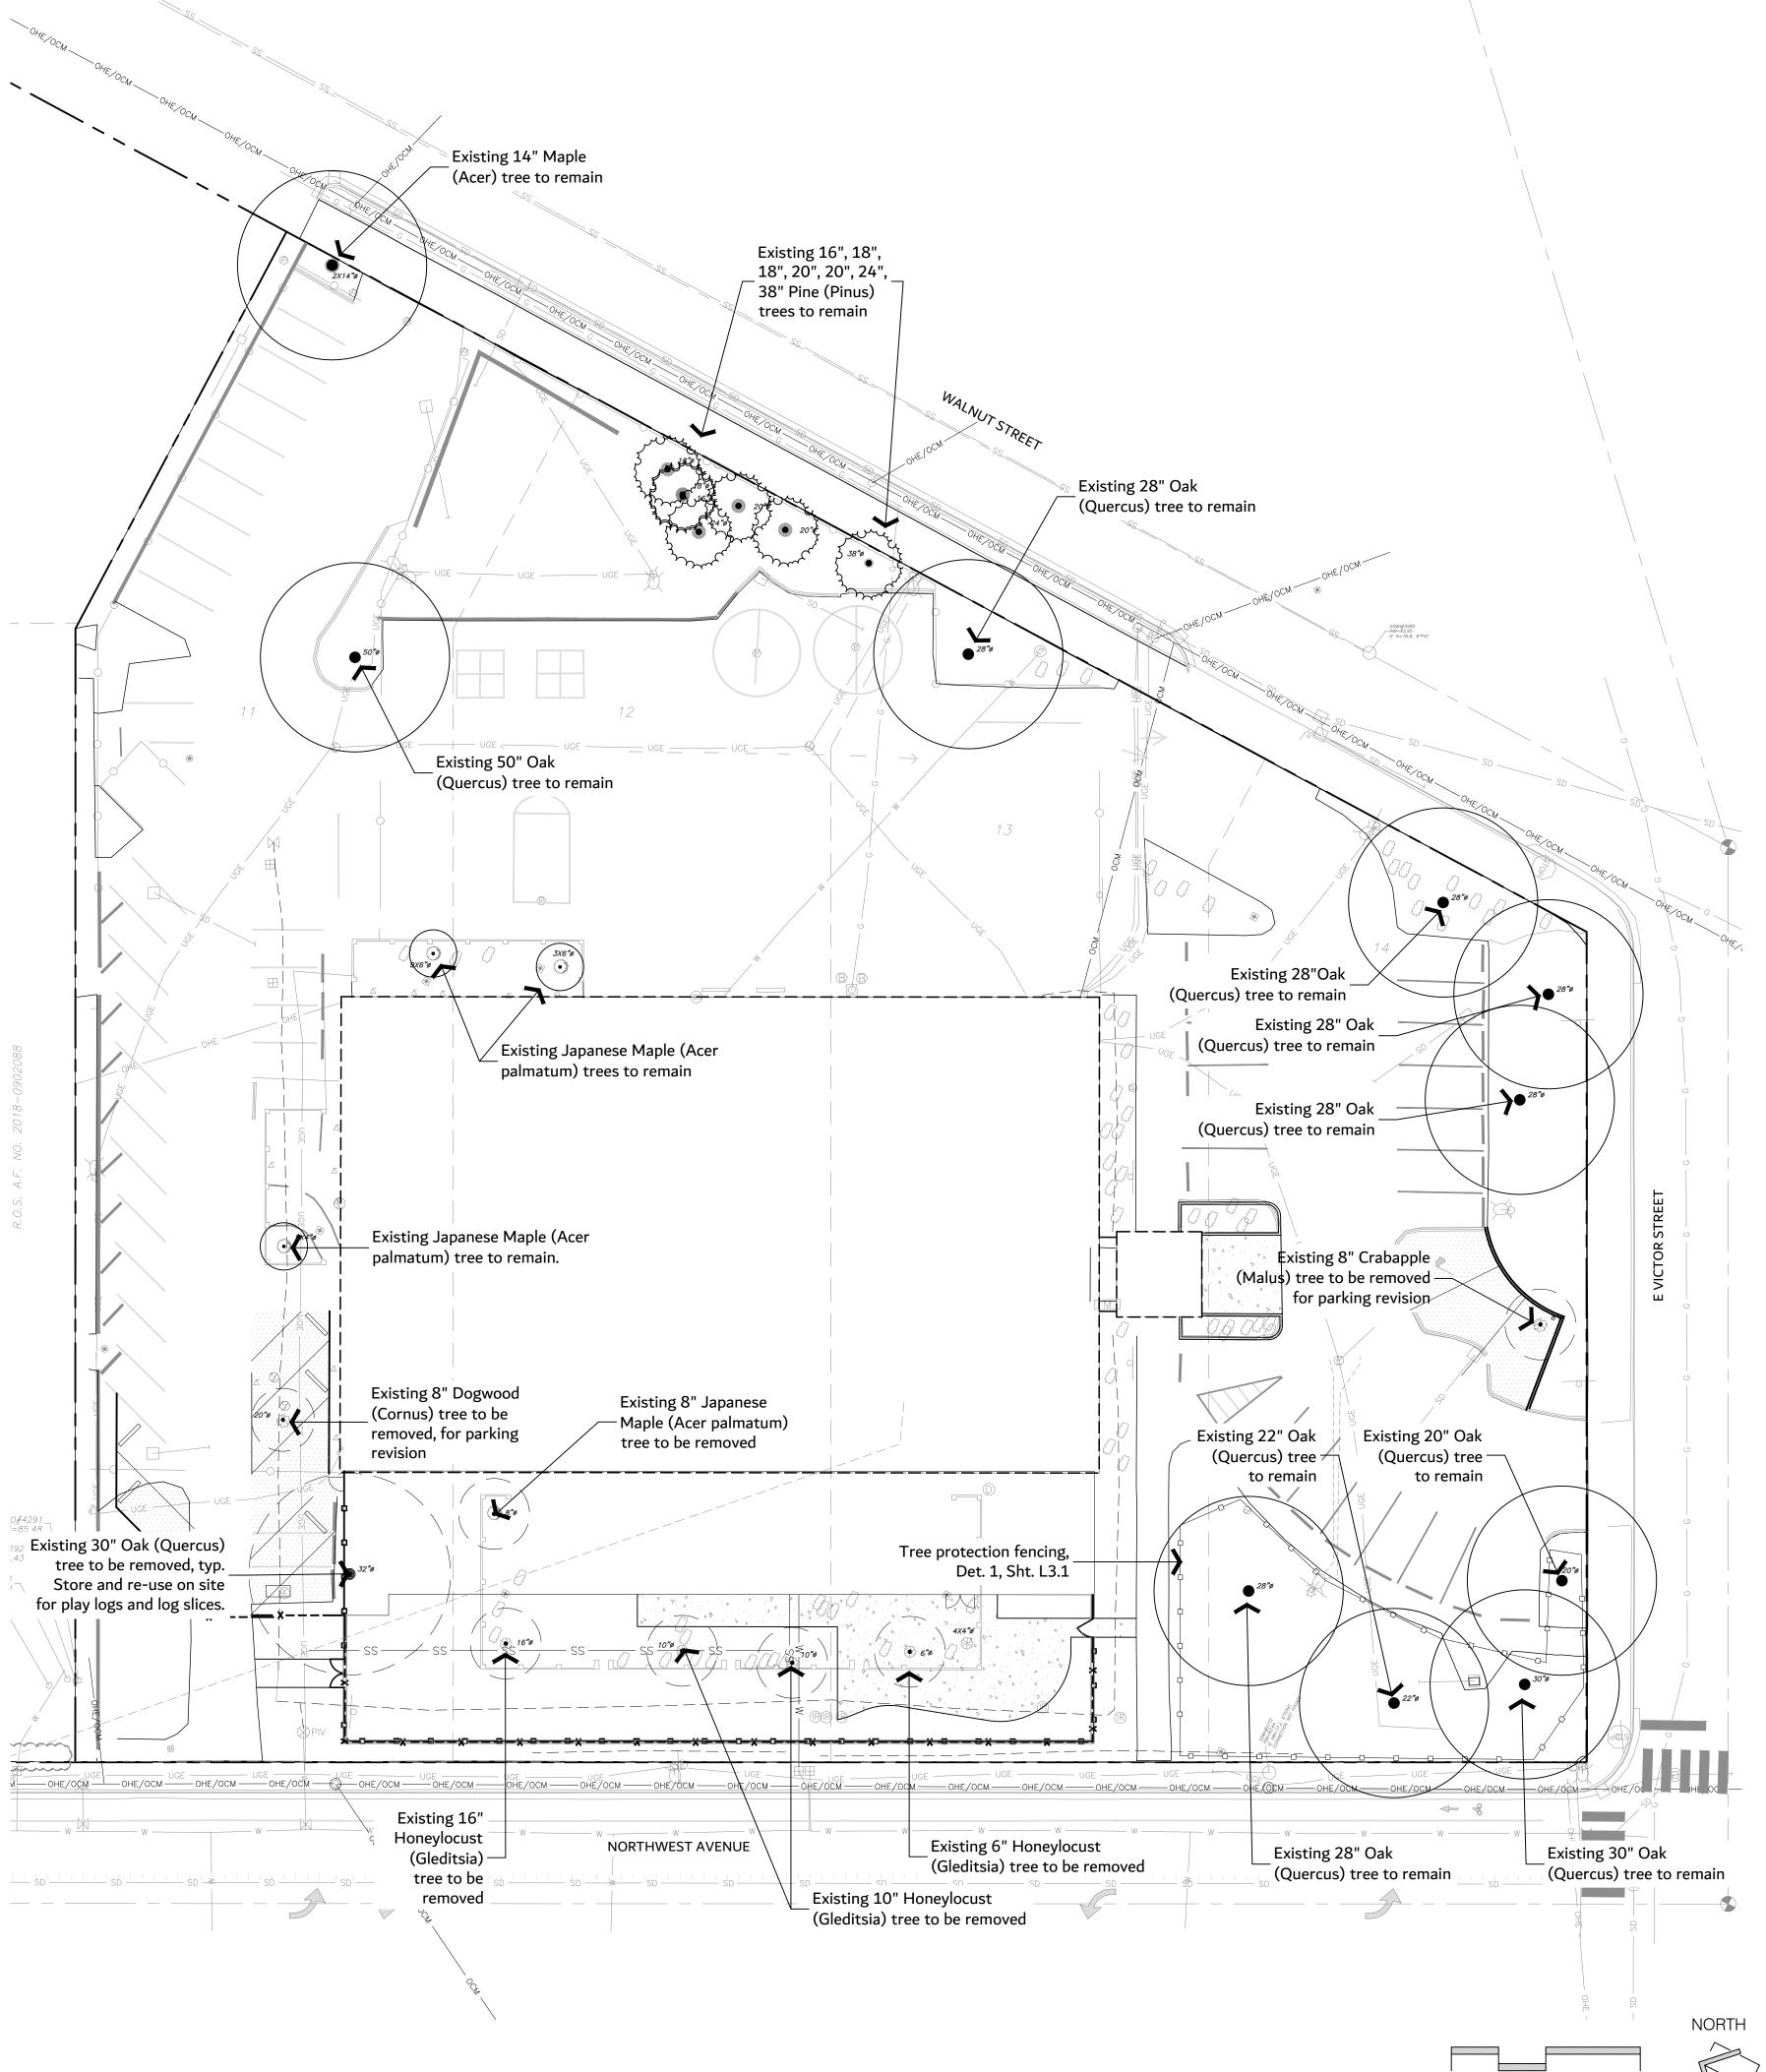



Franklin Academy Robin Hall Expansion

3000 Northwest Ave Bellingham,WA 98225



DESIGNED BY: PLA DRAWN BY: SPW


Date Issue 12-XX-23 Design Development

VV ZO DOSIGN DOVOIOPINON

Tree Retention Plan

13.1

SCALE: 1"=20'-0"

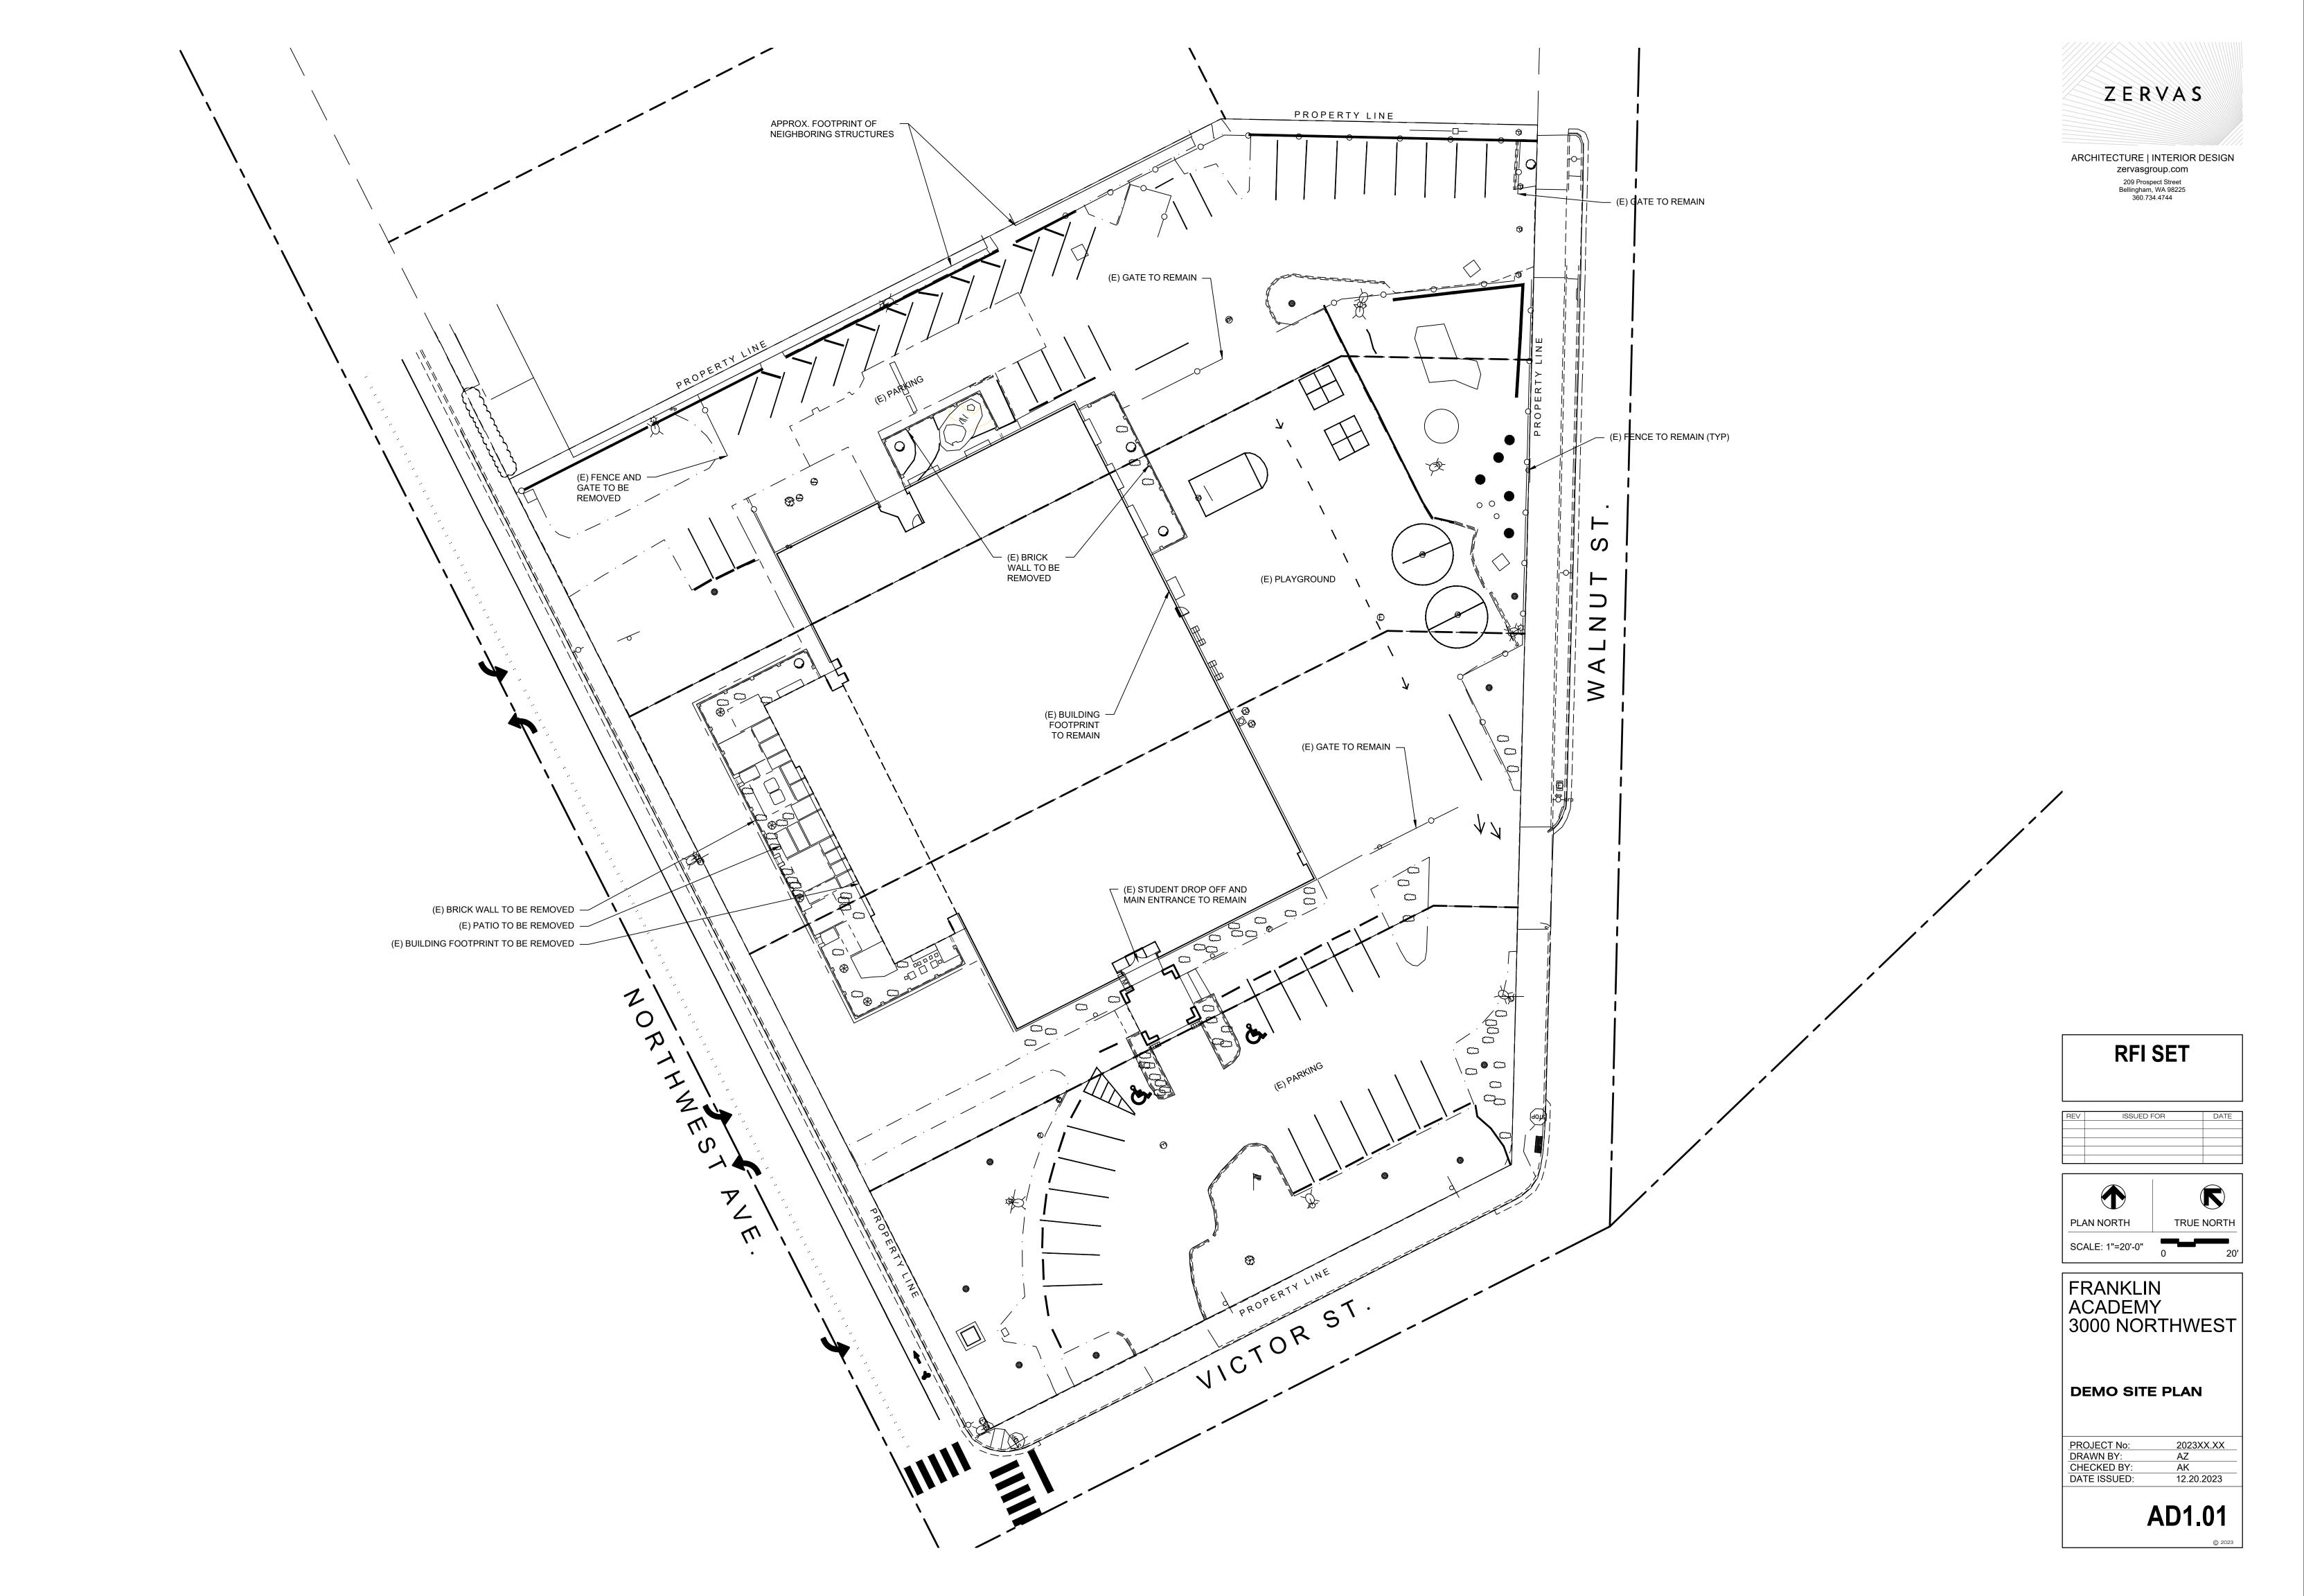



RFI SET

REV ISSUED FOR

NORTH.

SCALE.

1/8" = 1'-0"

ROBIN HALL


ROBIN HALL EXPANSION

DEMO PLAN

PROJECT#.


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ARCHITECTURE | INTERIOR DESIGN

PROJECT No:	2023XX.XX
DRAWN BY:	AZ
CHECKED BY:	AK
DATE ISSUED:	12.20.2023

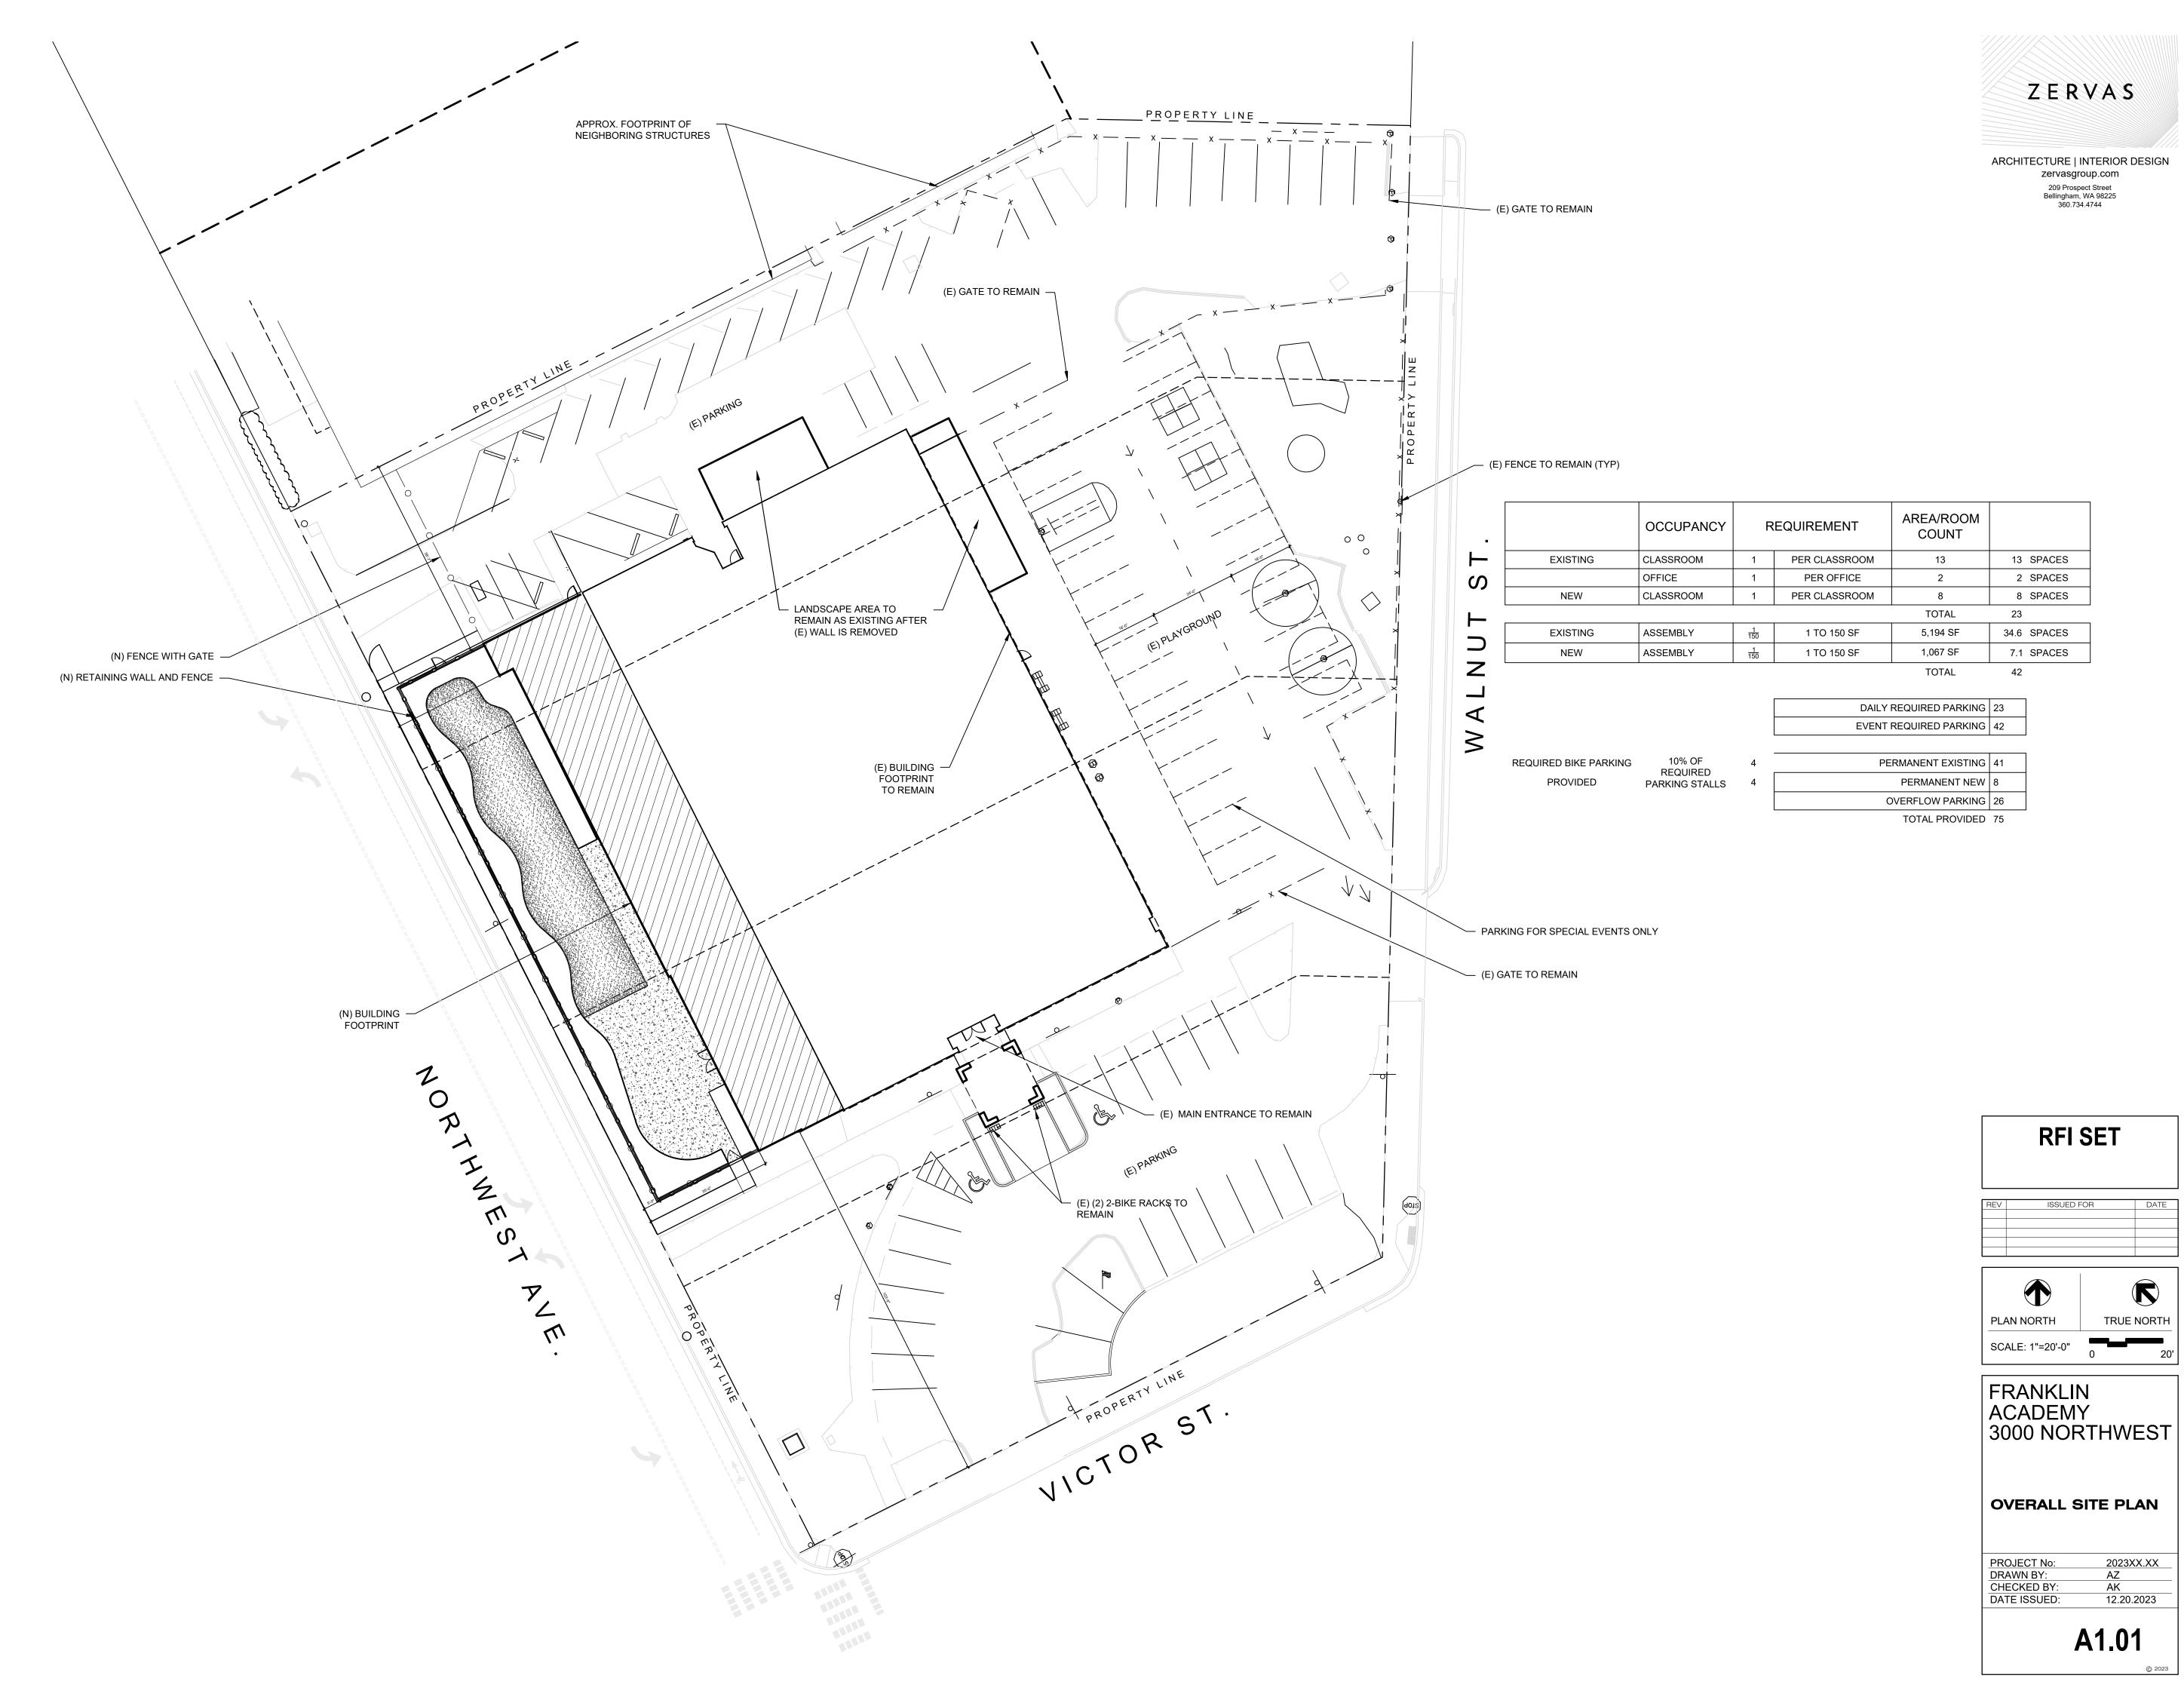



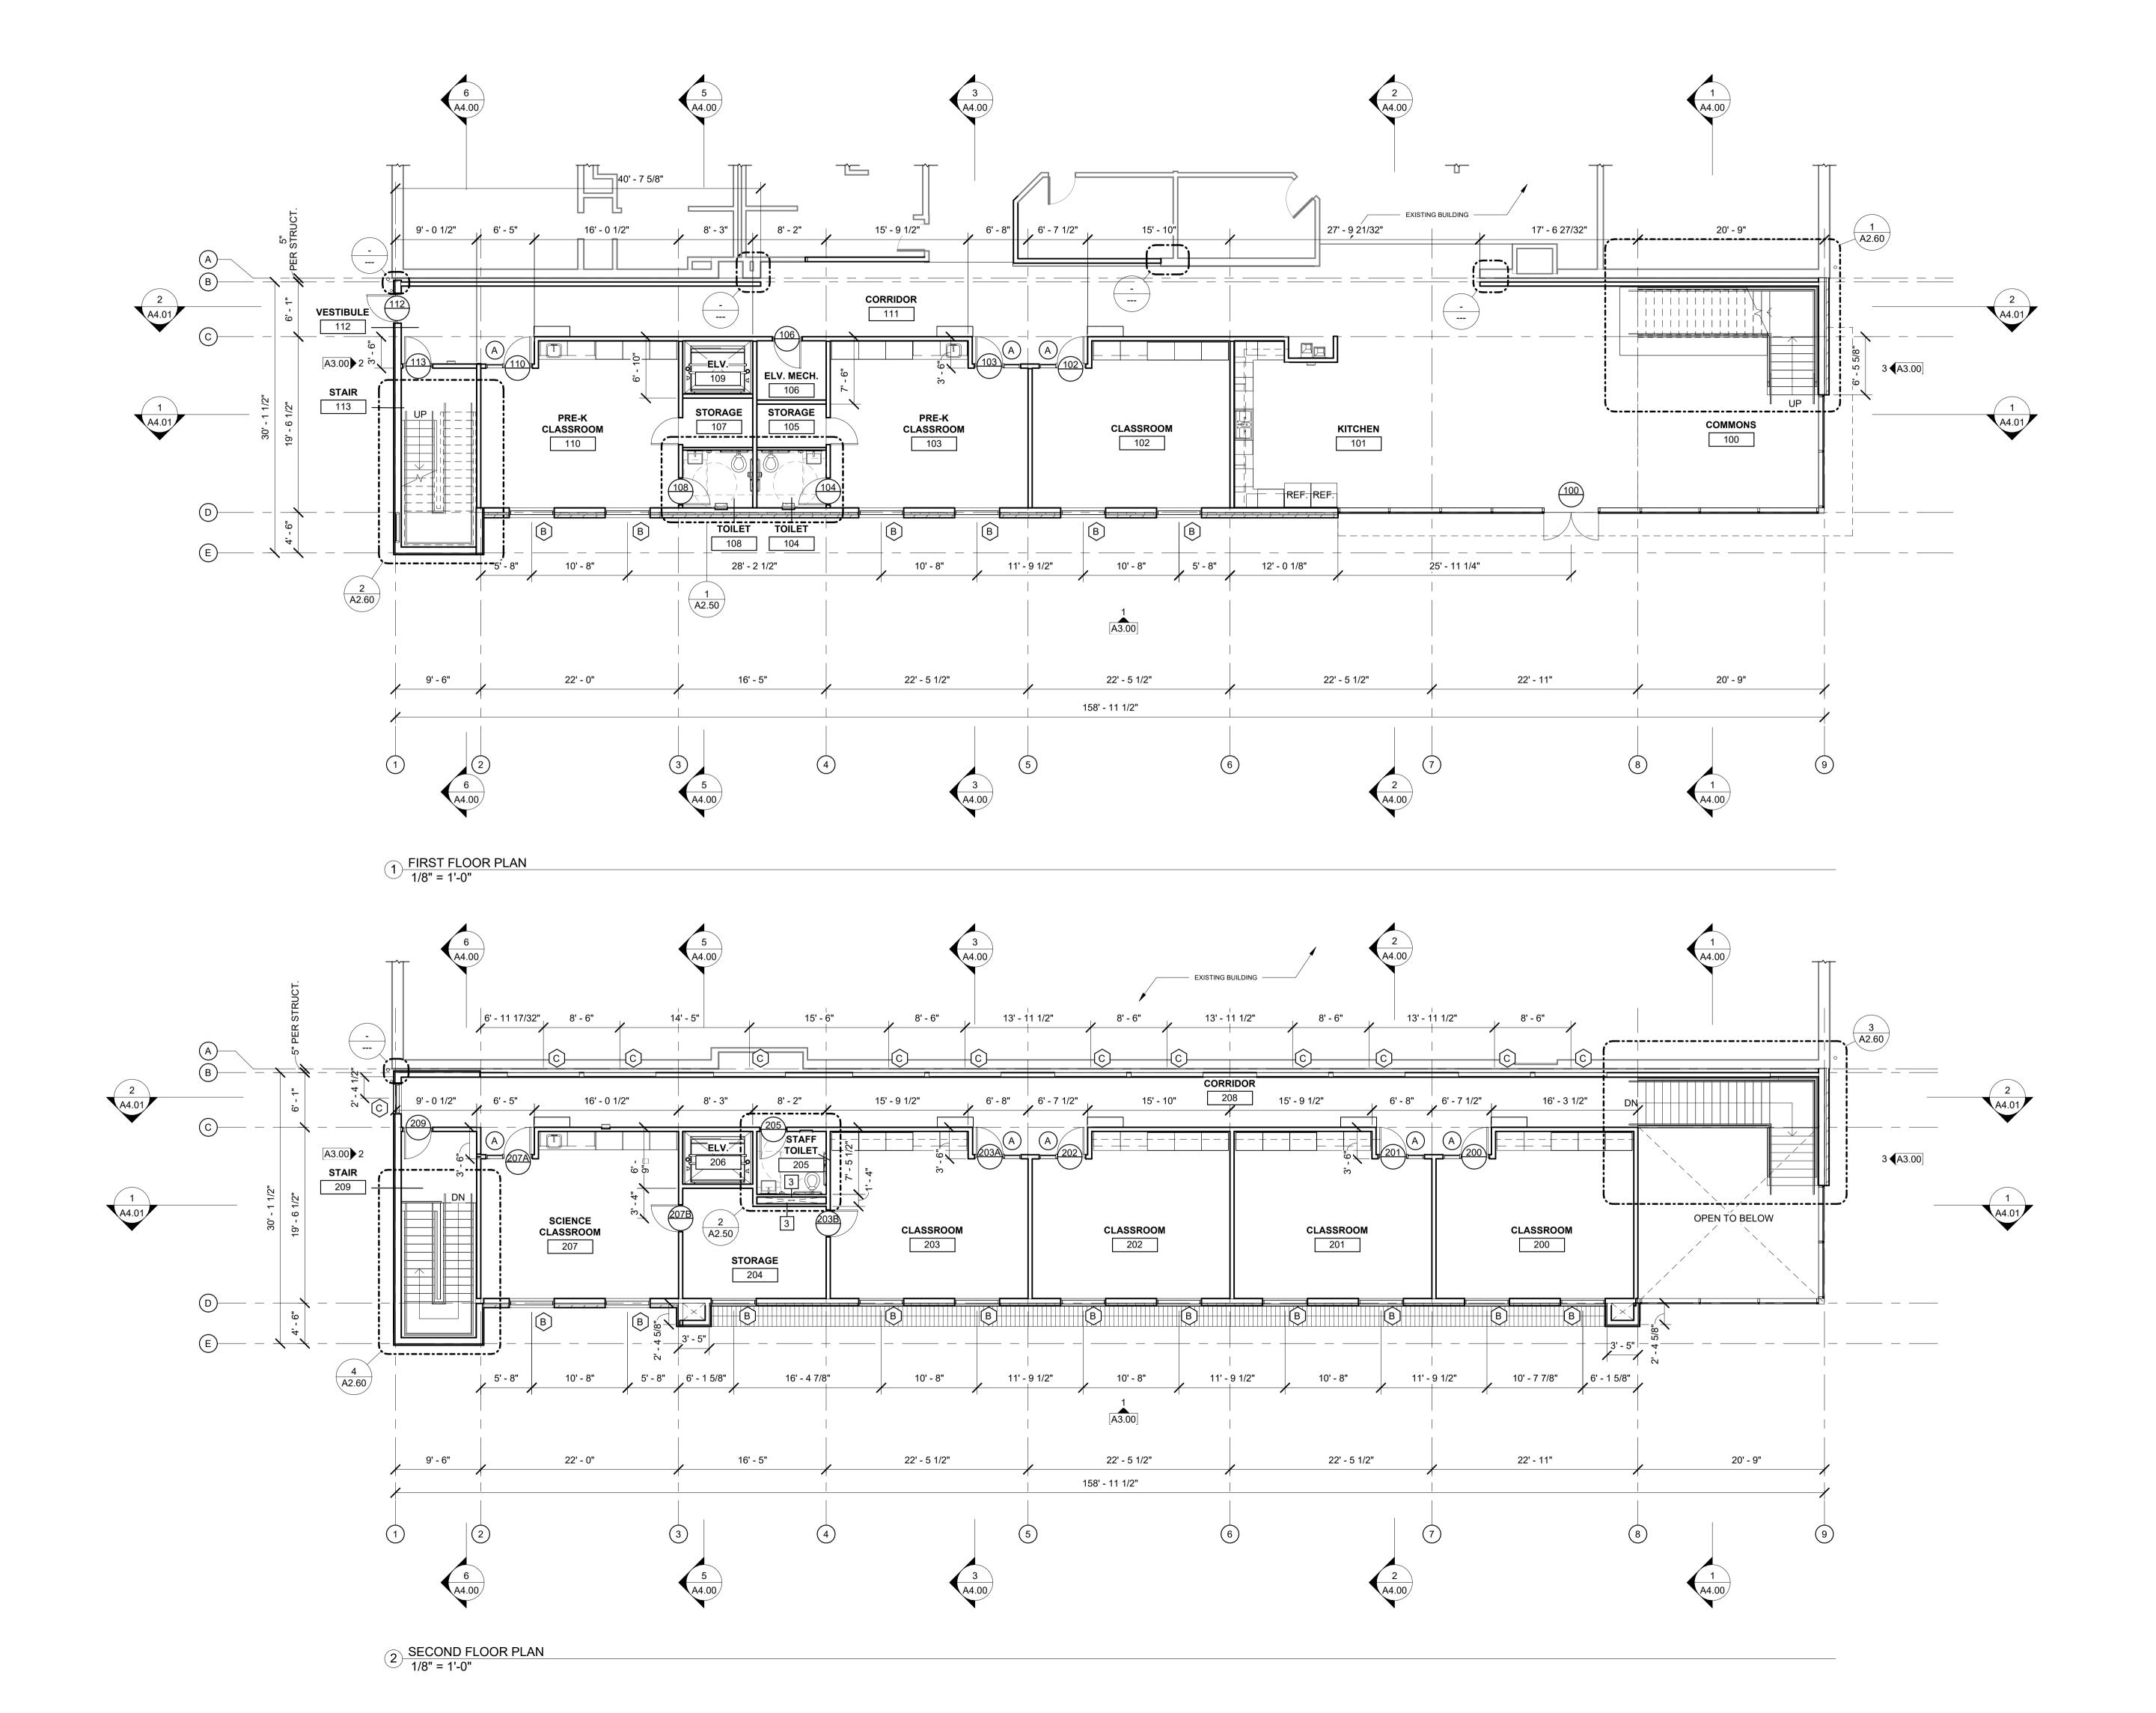


GENERAL NOTES


1. ALL INTERIOR WALLS TYPE "1"
UNLESS NOTED OTHERWISE. OMIT
GWB ON INTERIOR SIDE OF ALL
MECHANICAL AND PLUMBING CHASE
WALLS, TYP.

2. WALL DIMENSIONS ARE TO FACE OF STUD AND CONCRETE UNLESS NOTED OTHERWISE, TYP.

3. WHERE DOORS ARE SHOWN NEAR ADJACENT WALL PROVIDE 4" FROM DOOR OPENING TO FACE OF STUD OR CONCRETE UNLESS NOTED OTHERWISE, TYP.

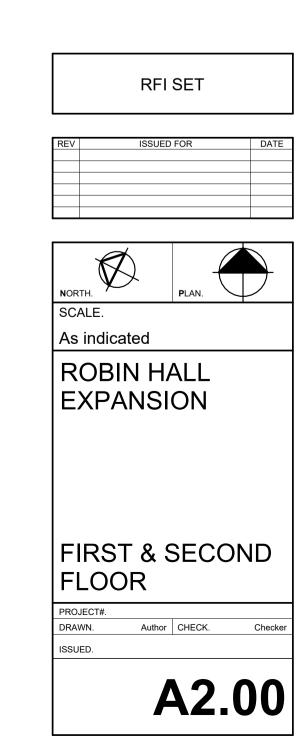



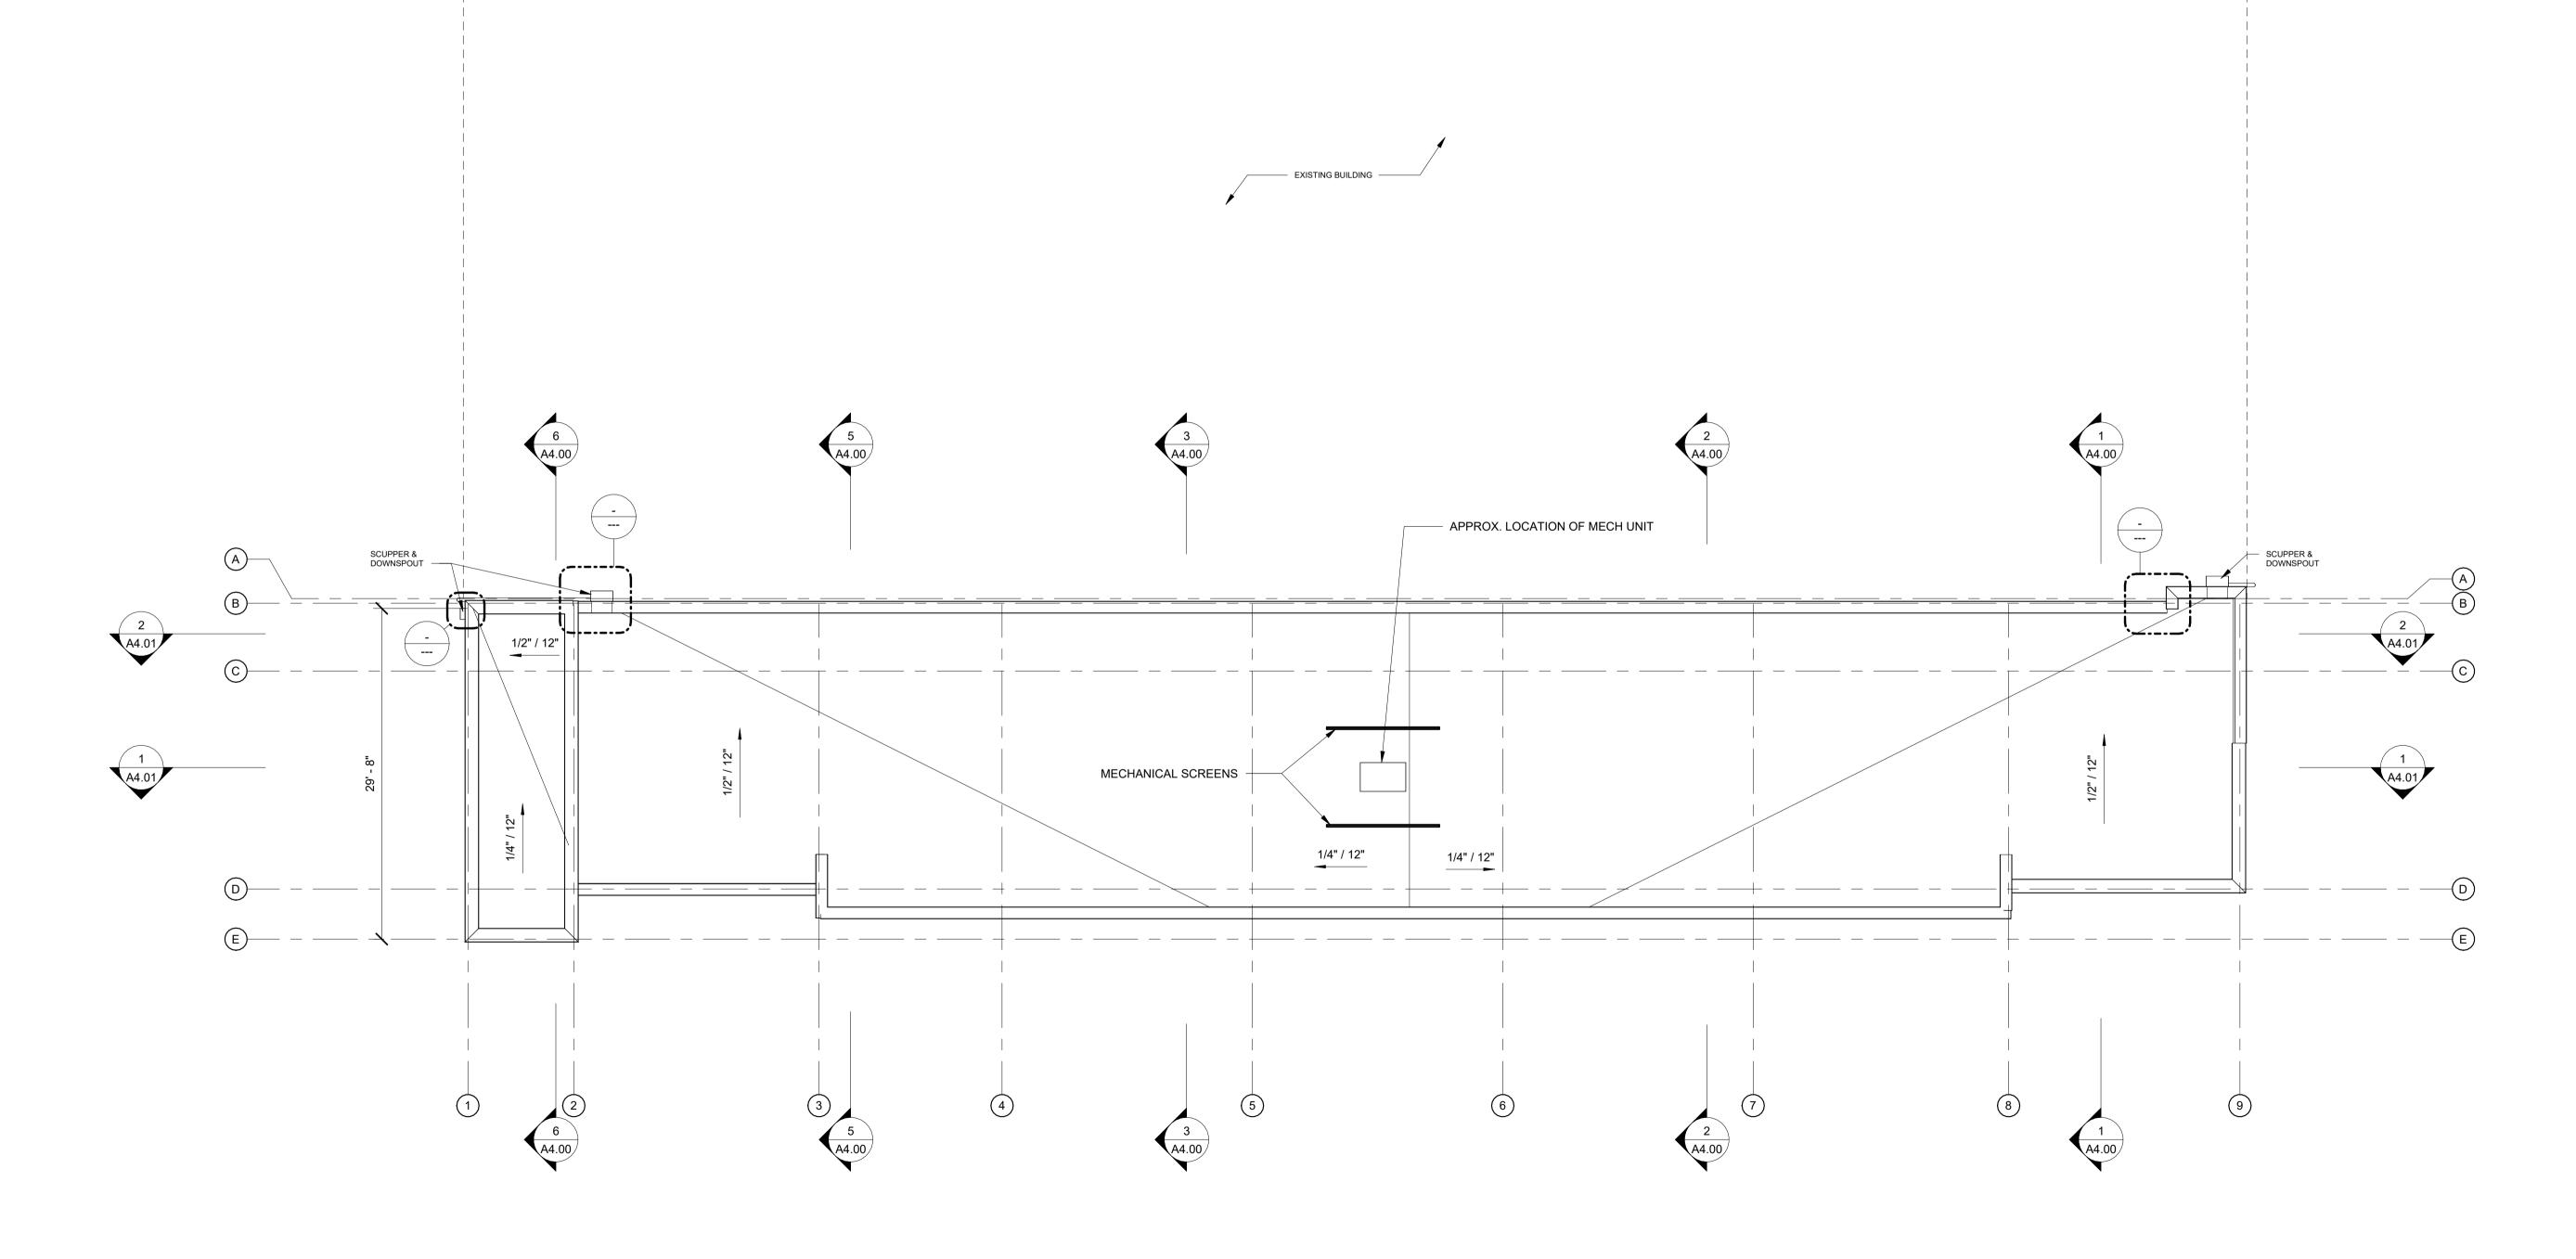

1 ROOF PLAN 1/8" = 1'-0"

RFI SET

REV ISSUED FOR

NORTH. PLAN.

SCALE.

1/8" = 1'-0"

ROBIN HALL EXPANSION


ROOF PLAN


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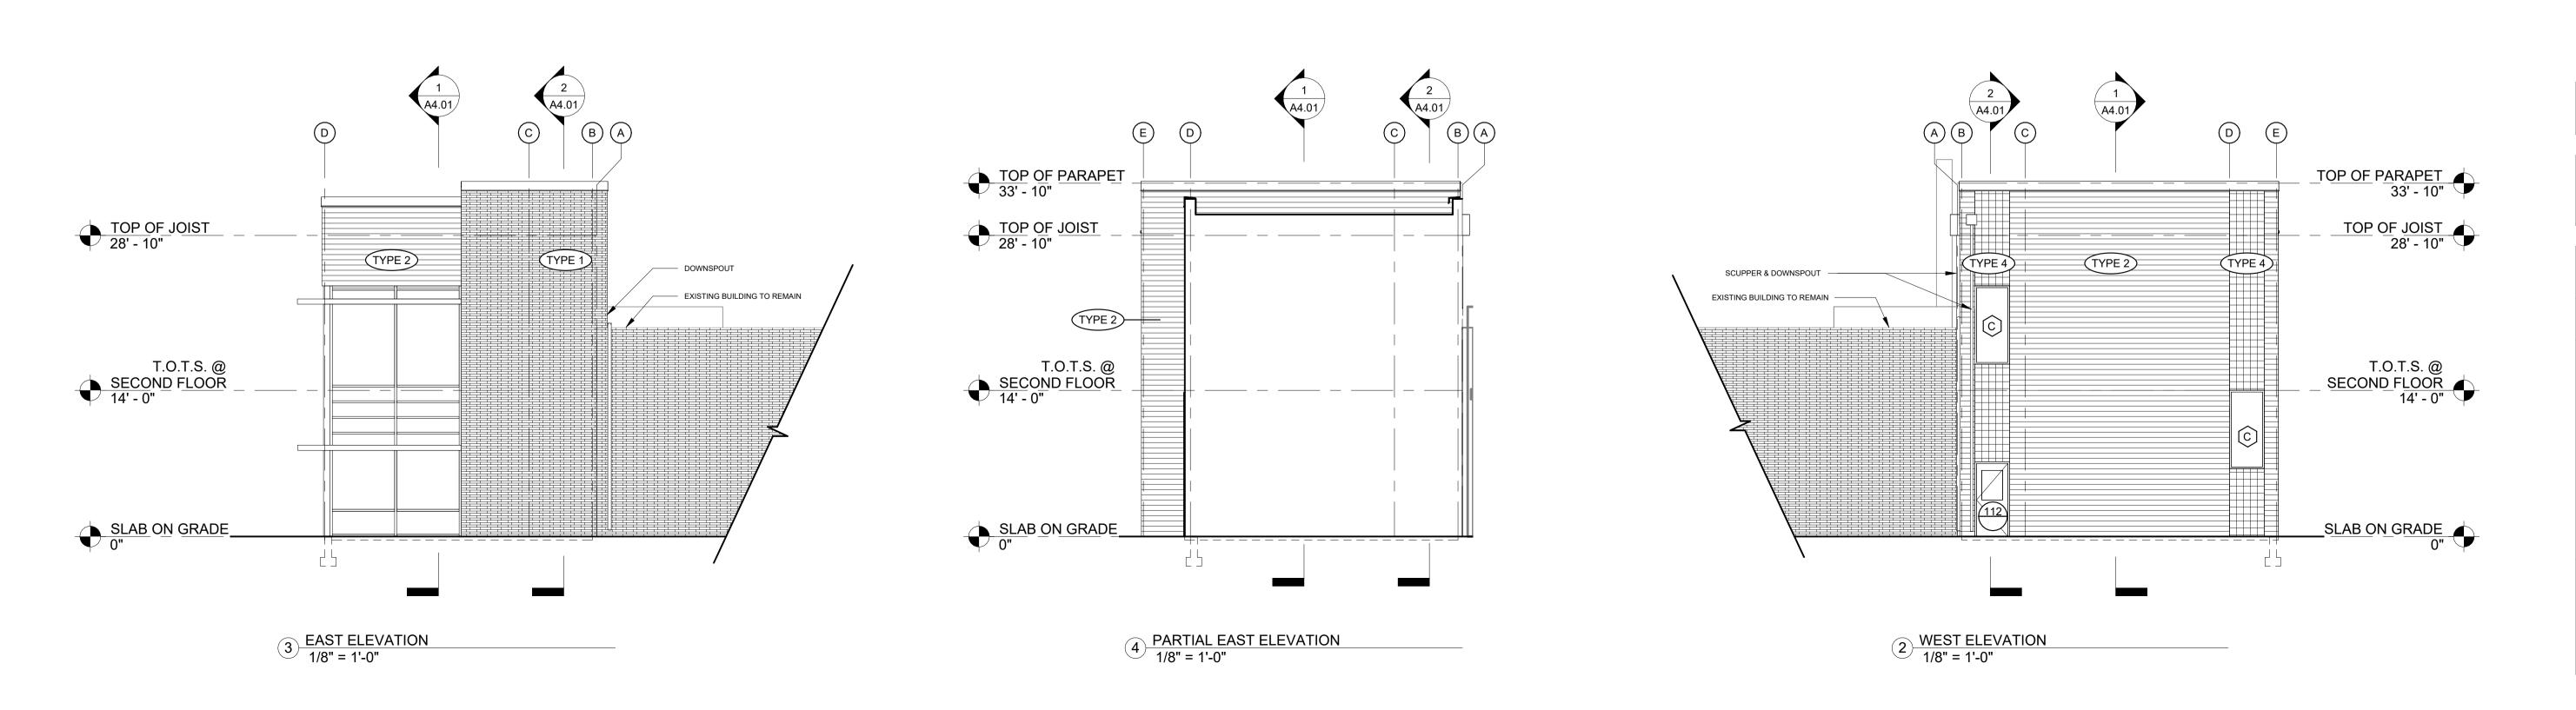
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ISSUED.

A2.10





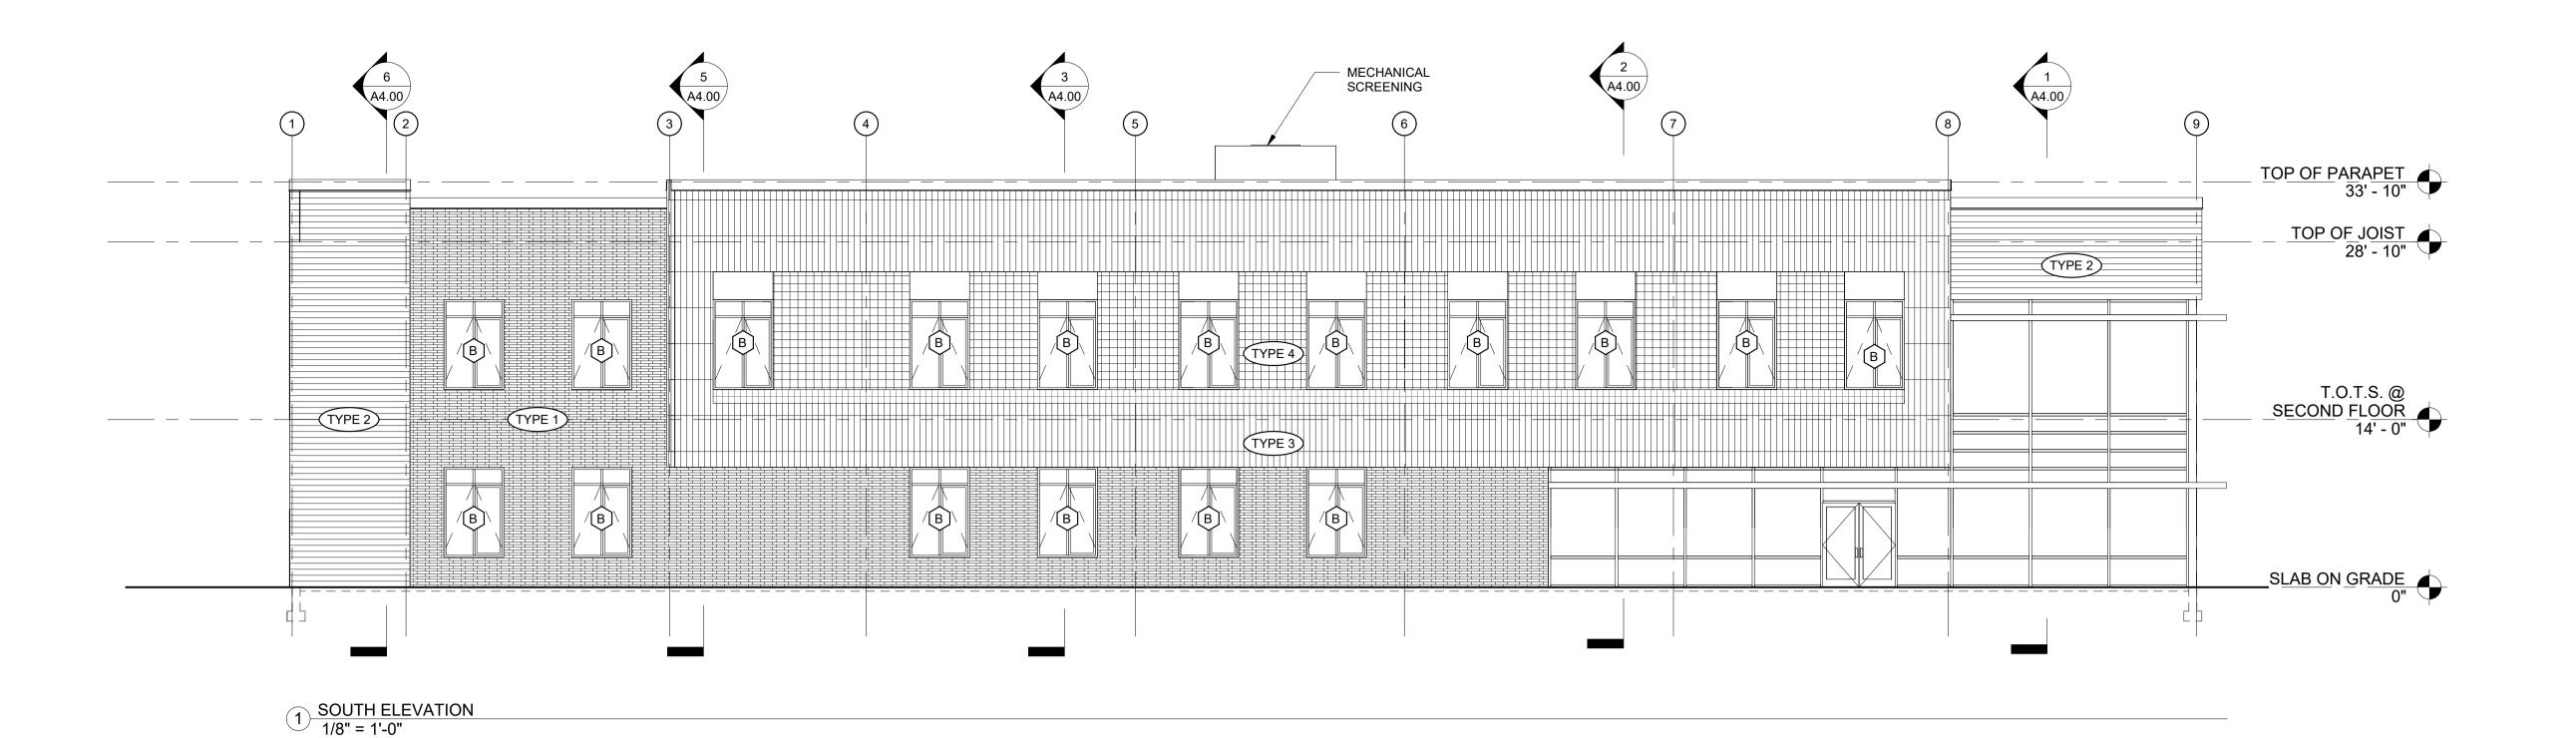

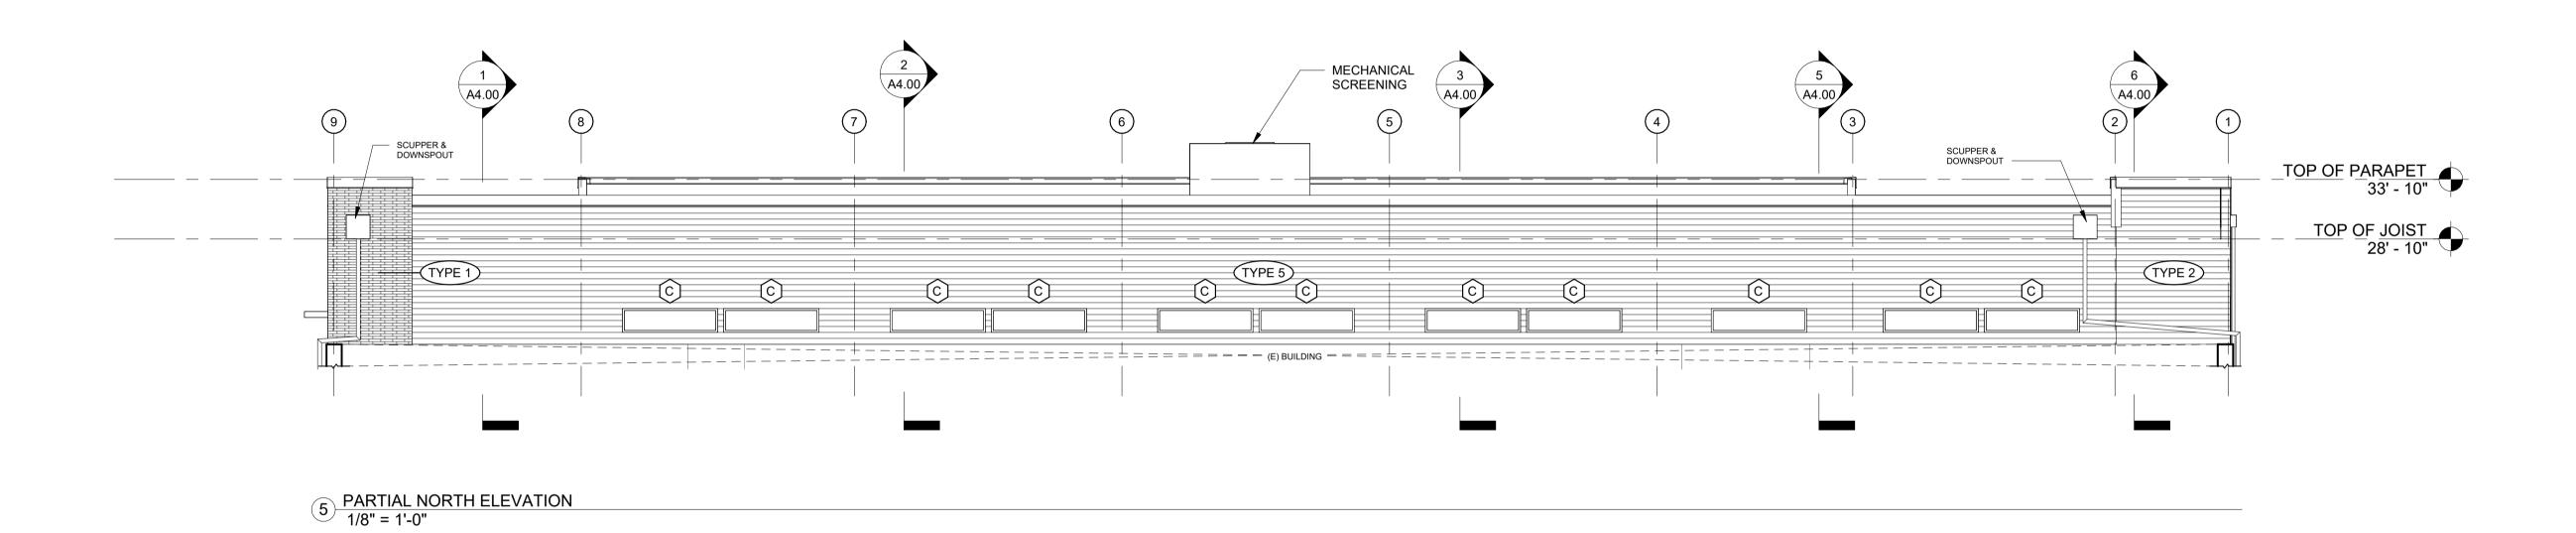ZERVAS

209 PROSPECT STREET - BELLINGHAM, WA 98225 p.360.734.4744 - zervasgroup.com

REGISTERED ARCHITECT

SIDING TYPE LEGEND

TYPE 1 BRICK VENEER

TYPE 2 WOOD COMPOSITE PANEL

TYPE 3 TILE

TYPE 4 TILE - 8 x 8

TYPE 5 FIBER CEMENT PANEL

RFI SET

REV ISSUED FOR

NORTH.

SCALE.
As indicated

ROBIN HALL
EXPANSION


EXTERIOR ELEVATIONS

Author CHECK.

A3.00





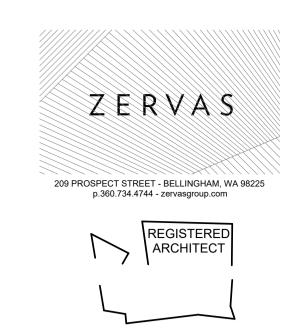

NORTH.

SCALE.

ROBIN HALL
EXPANSION

3D IMAGES (NOT USED)

PROJECT#.
DRAWN. Author CHECK. Checker
ISSUED.